	PLUMBING NOTES
1.	PLUMBING CONTRACTOR TO VERIFY ALL INCOMING SERVICES, MAKE ALL EXTERNAL, INTERNAL INTERCONNECTION, FINAL CONNECTIONS TO EQUIPMENT, AND PROVIDE ALL PIPING, FITTINGS, PARTS, ETC. NECESSARY TO MAKE EQUIPMENT FUNCTIONAL. UNLESS SPECIFICALLY STATED OTHERWISE.
2.	PLUMBING CONTRACTOR TO PROVIDE AND INSTALL INDIVIDUAL SHUT-OFF VALVES ON ALL WATER AND GAS LINES.
3.	ALL FLOOR AND WALL PENETRATIONS MUST BE SEALED WATER-TIGHT AND VERMIN PROOF.
4.	PLUMBING CONNECTIONS INDICATED ARE THOSE REQUIRED FOR THE FOODSERVICE EQUIPMENT. (SEE ARCHITECTURAL PLUMBING SHEETS FOR ADDITIONAL REQUIREMENTS AND INFORMATION)
5.	ALL HORIZONTAL DIMENSIONS SHOWN ARE FROM FINISHED FACE OF WALL OR GRID LINE TO CENTERLINE OF STUB-OUT UNLESS OTHERWISE NOTED ON PLANS OR DETAILS. PLUMBER TO VERIFY ALL DIMENSIONS AT JOB SITE.
6.	ALL FLOOR SINKS SHOWN ARE TO BE SET FLUSH WITH FINISHED FLOOR UNLESS LOCAL CODES DICTATE OTHERWISE. FLOOR SINKS INDICATED HALF-IN AND HALF-OUT OF CURB TO BE FLUSH WITH FINISHED FLOOR.
7.	PLUMBING CONTRACTOR TO PROVIDE AND INSTALL REMOVABLE GRILLS OR COVERS FOR ALL FULLY OR PARTIALLY EXPOSED FLOOR SINKS.
8.	PLUMBING CONTRACTOR TO PROVIDE AND INSTALL TYPE "L" COPPER TUBING DRAIN LINES FROM ALL APPLICABLE EQUIPMENT TO FLOOR SINKS, INCLUDING WALK-IN COOLER AND FREEZER COILS AND TO INSULATE ALL DRAIN LINES FROM ICE BINS, REFRIGERATION EQUIPMENT, OR OTHER EQUIPMENT CAPABLE OF PRODUCING CONDENSATION.
9.	FLOOR SINKS FOR DISHWASHING MACHINE AND SCULLERY SINK SHALL BE A MINIMUM 12" X 12" X 10" DEEP AND HAVE A MINIMUM 3" DRAIN PIPE.
10.	IF INLET PRESSURE ON HOT WATER LINE IS IN EXCESS OF 25 PSI PLUMBING CONTRACTOR WILL PROVIDE AND INSTALL A PRESSURE REGULATING VALVE.
11.	IF KEC IS TO PROVIDE FIRE SUPPRESSION SYSTEM, GAS VALVE WILL BE SHIPPED LOOSE TO SITE FOR INSTALLATION BY OTHER.
12.	PLUMBING CONTRACTOR TO PROVIDE AND INSTALL NECESSARY UTILITIES FOR MAKE-UP AIR FANS. (VERIFY LOCATIONS AND REQUIREMENTS WITH MECHANICAL ENGINEER.)
13.	PLUMBING CONTRACTOR TO PROVIDE AND INSTALL LINE STRAINERS OR APPROVED TYPE FILTERS ON GAS SUPPLY LINES.
14.	PLUMBING ENGINEER TO ADEQUATELY SIZE HOT WATER TANK TO MEET WATER CONSUMPTION REQUIREMENTS AS DETERMINED BY LOCAL HEALTH DEPARTMENT.
15.	KITCHEN EQUIPMENT CONTRACTOR TO PROVIDE, WHERE SPECIFICALLY STATED, AND PLUMBING CONTRACTOR TO INSTALL QUICK DISCONNECT GAS HOSES FOR FOODSERVICE EQUIPMENT.
16.	PLUMBING CONTRACTOR TO PROVIDE CHROME PLATED PIPES AND FITTINGS FOR ALL EXPOSED CONNECTION RUNS AS REQUIRED.
17.	PLUMBING ENGINEER TO SPECIFY, AND PLUMBING CONTRACTOR TO PROVIDE AND INSTALL GREASE INTERCEPTOR OR TRAP AND BACKFLOW PREVENTERS WHERE REQUIRED.
18.	PLUMBING CONTRACTOR TO VERIFY ALL DIMENSIONS INDICATED & SITE CONDITIONS.
19.	PLUMBING CONTRACTOR TO VERIFY ANY ADDITIONAL SERVICES REQUIRED ELSEWHERE IN THE BUILDING, ITEMS NOT SHOWN ON THIS PLAN, AND NOT IN CONTRACT ITEMS.
20.	PLUMBING CONTRACTOR TO USE EXISTING SERVICES TO CONNECT NEW AND REUSED EQUIPMENT WHENEVER POSSIBLE, AND TO CAP OFF ANY EXISTING SERVICES MADE OBSOLETE.
21.	PLUMBING CONTRACTOR TO VERIFY REFRIGERATION DRAIN LINE LOCATIONS WITH KITCHEN EQUIPMENT CONTRACTOR.
22.	ALL INDIRECT DRAIN LINES INCLUDING WALK-IN COOLER/ FREEZER TO HAVE A MINIMUM SLOPE OF 1/4" PER 1'-0".
23.	PLUMBING CONTRACTOR TO MOUNT WALK-IN COOLER/ FREEZER DRAIN LINES 1" FROM WALL FOR CLEANING.
24.	PLUMBING CONTRACTOR TO INSTALL ALL HAND SINKS, MOP SINKS, AND FLOOR TROUGHS THAT ARE SPECIFIED TO BE SUPPLIED BY THE KITCHEN EQUIPMENT CONTRACTOR.
25.	PLUMBING CONTRACTOR TO PROVIDE MINIMUM 120°F HOT WATER TO THREE COMPARTMENT SINK.
26.	PLUMBING CONTRACTOR TO PROVIDE NATURAL GAS PRESSURE OF 6" W.C. TO COOKING EQUIPMENT.
27.	ALL PLUMBING FIXTURES SPECIFIED TO BE PROVIDED BY KEC SUCH AS FAUCETS, DRAINS, VACUUM BREAKERS, WATER HOSES, ETC. WILL BE PROVIDED LOOSE BY KEC FOR INSTALLATION BY PLUMBING CONTRACTOR.

	ELECTRICAL NOTES
1.	ELECTRICAL CONTRACTOR TO VERIFY ALL INCOMING SERVICES AND FINAL HOOK-UPS TO ALL APPLICABLE EQUIPMENT AND TO PROVIDE ALL SWITCHES, BREAKERS, CONDUIT, PULL BOXES, ETC., UNLESS SPECIFICALLY STATED OTHERWISE.
2.	ELECTRICAL CONTRACTOR TO PROVIDE ALL JUNCTION BOXES, OUTLETS, AND RECEPTACLES IN FIXTURES. FIXTURE FABRICATOR TO LOCATE ALL RECEPTACLES AND SWITCHES WHEN PART OF FIXTURE. INTERNAL WIRING TO BE PROVIDED AND INSTALLED BY THE JOBSITE ELECTRICAL CONTRACTOR.
3.	ELECTRICAL CONNECTIONS INDICATED ARE THOSE REQUIRED FOR THE FOODSERVICE EQUIPMENT. (SEE ARCHITECTURAL PLANS FOR ADDITIONAL ELECTRICAL REQUIREMENTS.) ELECTRICAL CONTRACTOR TO VERIFY REQUIREMENTS FOR ADDITIONAL CONVENIENCE OUTLETS AND NOT IN CONTRACT ITEMS.
4.	ALL HORIZONTAL DIMENSIONS SHOWN ARE FROM FINISHED FACE OF WALL OR GRID LINE TO CENTERLINE OF OUTLET UNLESS OTHERWISE NOTED ON PLANS OR DETAILS. ELECTRICAL CONTRACTOR TO VERIFY ALL DIMENSIONS AT JOB SITE.
5.	ELECTRICAL CONTRACTOR TO PROVIDE 6'-0" PIGTAIL FLEX CONDUIT AT ALL DIRECT CONNECT STUB-OUTS THAT ARE WITH-IN CABINET BODIES. EXTEND AND CONNECT TO FIXTURES.
6.	ELECTRICAL CONTRACTOR TO WIRE MAGNETIC CONTACTOR(S) OR PROVIDE SHUNT TRIP BREAKER(S) FOR POWER SHUT-OFF FOR ALL ELECTRICAL OUTLETS THAT ARE PROTECTED BY THE FIRE PROTECTION SYSTEM. CONNECT 120V CONTROL CIRCUIT FROM MICRO-SWITCH SYSTEM ON CYLINDER MOUNT TO CONTACTOR COIL.
7.	ELECTRICAL CONTRACTOR TO RUN IN CONDUIT ALL LINES OR LOW VOLTAGE CONTROL WIRING FROM WALK-IN FREEZER EVAPORATOR AS DETAILED ON FOODSERVICE REFRIGERATION SYSTEM DETAILS DRAWINGS
8.	ELECTRICAL CONTRACTOR TO PROVIDE AND INSTALL SERVICE ON ROOF FOR EXHAUST AND MAKE-UP AIR SYSTEMS (VERIFY LOCATION).
9.	ELECTRICAL CONTRACTOR TO PROVIDE AND INSTALL STAINLESS STEEL COVER PLATES FOR ALL RECEPTACLES AND SWITCHES IN FOOD PREPARATION AREA UNLESS OTHERWISE NOTED. ALL RECEPTACLES ABOVE BACK SPLASH TO BE SET HORIZONTAL
10.	ELECTRICAL CONTRACTOR TO PROVIDE AND INSTALL ALL GENERAL LIGHTING FIXTURES COMPLETE WITH LAMPS NOT SPECIFIED TO BE PROVIDED BY KEC. IN ADDITION, ELECTRICAL CONTRACTOR TO SUPPLY LAMPS FOR ALL FOODSERVICE EQUIPMENT THAT IS NOT PROVIDED STANDARD BY THE MANUFACTURER.
11.	ELECTRICAL CONTRACTOR TO PROVIDE CAPS AND CORDS FOR ALL ITEMS WHICH USE CONVENIENCE OUTLETS WHEN NOT SUPPLIED BY MANUFACTURER AND SHORTEN ANY CORDS AS REQUIRED
12.	ELECTRICAL CONTRACTOR TO INSTALL FLY FAN(S) AND/ OR AIR CURTAIN(S), INCLUDING SWITCHING AND ACCESSORIES (I.E. DOOR SWITCHES) PROVIDED BY KITCHEN EQUIPMENT CONTRACTOR UNLESS SPECIFICALLY STATED OTHERWISE.
13.	ELECTRICAL CONTRACTOR TO PROVIDE AND INSTALL CONDUIT FOR PULL-THRU OF REFRIGERATION AND BEVERAGE LINES AS SHOWN ON PLAN WITH A MINIMUM BENDING RADIUS OF 24" FOR 4"Ø CONDUIT OR A MINIMUM BENDING RADIUS OF 36" FOR 6"Ø CONDUIT OR LARGER. LONG SWEEP CONDUIT RECOMMENDED, (NO FACTORY "L'S" PERMITTED)
14.	ELECTRICAL CONTRACTOR TO VERIFY ALL REQUIREMENTS FOR HOT WATER TANK WITH HEALTH DEPARTMENT CONDITIONS.
15.	ELECTRICAL CONTRACTOR TO PROVIDE AND INSTALL MECHANICAL VENTILATION WITH LIGHT AND SWITCH IN RESTROOMS AND CHANGE ROOMS. (MINIMUM AIR EXCHANGE AS REQUIRED BY LOCAL CODES)
16.	KITCHEN EQUIPMENT CONTRACTOR SHALL CUT ACCESS HOLES FOR CONVENIENCE OUTLETS IN BACKSPLASHES, ETC., ELECTRICAL CONTRACTOR TO PROVIDE EXTENSION SHIELDS IF REQUIRED.
17.	ELECTRICAL CONTRACTOR TO CONNECT ALL INDIVIDUAL COMPRESSORS AND/ OR CONDENSERS. ELECTRCIAL CONTRACTOR SHALL ALSO PROVIDE DISCONNECT SWITCHES AND MAGNETIC STARTERS AS REQUESTED.
18.	ELECTRICAL CONTRACTOR TO PROVIDE AND INSTALL ALL WIRING FOR WALK-IN COOLERS/ FREEZERS ON THE EXTERIOR OF THE BOX WHENEVER POSSIBLE. VERIFY REQUIREMENTS WITH REFRIGERATION CONTRACTOR PRIOR TO INSTALL.
19.	IF KEC IS SPECIFIED TO PROVIDE WALK IN LIGHT FIXTURES, THEY WILL BE DELIVERED TO THE SITE FOR INSTALLATION BY ELECTRICAL CONTRACTOR. ELECTRCIAL CONTRACTOR TO SUPPLY LAMPS FOR ALL WALK-IN COOLERS/ FREEZERS IF NOT PROVIDED STANDARD FROM MANUFACTURER
20.	ELECTRICAL CONTRACTOR TO MAKE ALL FINAL ELECTRICAL CONNECTION FOR THE WALK INS. INCLUDING DRAIN LINE HEAT TAPE(S) AND PRESSURE RELIEF PORT(S).
21.	ELECTRICAL CONTRACTOR TO USE EXISTING ELECTRICAL SERVICES TO CONNECT NEW AND RE-USED EQUIPMENT WHENEVER POSSIBLE, AND TO CAP-OFF ANY EXISTING SERVICES MADE OBSOLETE.
22.	ELECTRICAL CONTRACTOR TO VERIFY ALL DIMENSIONS AT JOB SITE.
23.	ELECTRICAL CONTRACTOR TO SEAL INTERIOR AND EXTERIOR OF ANY CONDUIT PENETRATIONS THRU WALK IN COOLER TO PREVENT CONDENSATION BUILD UP.

	SPECIAL CONDITION NOTES		GENERAL NOTES
1.	CHASE BELOW THE FLOOR FOR THE BEVERAGE LINES. PROVIDE ELBOWS WITH A 30" MINIMUM DIAMETER RADIUS AT ALL CHASE TURNS. STUB-UP 6" AT EACH END OF THE CHASE.	1.	ANY DISCREPANCIES BETWEEN PLANS, BULDING, A CODE REQUIREMENTS THAT MAY EFFECT THE INST OR OVERALL FABRICATION WORK IN ANY WAY SHAI BROUGHT TO THE ATTENTION OF THE KTICHEN EQU
•	THE CHASE IS TO BE WATERTIGHT WHEN KITCHEN EQUIPMENT CONTRACTOR IS SPECIFICALLY REQUIRED TO HANG EXHAUST HOODS THEY WILL PROVIDE HANGER ROD SUPPORTS TO MAXIMUM OF + 6'-0" ABOVE HOOD	2.	CONTRACTOR IMMEDIATELY BY THE GENERAL CON GENERAL CONTRACTOR TO PROVIDE AND INSTALL PLATFORM FOR COMPRESSORS, EXHAUST AND MA FANS (VERIFY LOCATION)
	TO SUPPORT STRUCTURE ABOVE PROVIDED BY OTHERS. SUPPORTS AND CONNECTIONS TO STRUCTURE TO BE BY STRUCTURAL ENGINEER OF RECORD AND NOT INCLUDED IN THE KITCHEN EQUIPMENT CONTRACTORS SCOPE.	3.	GENERAL CONTRACTOR TO PROVIDE ALL PENETRA BETWEEN FLOORS AND/ OR CEILINGS FOR UTILITES REFRIGERATION CONDUITS AS REQUIRED.
3.	GENERAL CONTRACTOR TO PROVIDE AND INSTALL NON- COMBUSTIBLE WALL REQUIRED AT EXHAUST HOOD LOCATIONS TO EXTEND A MINIMUM OF 18" IN ALL DIRECTIONS.	4.	GENERAL CONTRACTOR TO PROVIDE AND INSTALL JACKS OR PITCH POCKET FOR REFRIGERATION LIN PENETRATIONS THRU ROOF. VERIFY LOCATION W
4.		5.	KITCHEN EQUPMENT CONTRACTOR. GENERAL CONTRACTOR SHALL PROVIDE AND INST BACKING IN WALLS FOR MOUNTING OF WALL SHEL
5. 6.	GENERAL CONTRACTOR TO PROVIDE ALL WALL BACKING REQUIRED FOR FOODSERVICE EQUIPMENT. ANY ATTACHMENT TO BUILDING STRUCTURE FOR LOAD	6.	RACKS, HOSE REELS, AND FOODSERVICE EQUIPMI REQUIRED. ALL HORIZONTAL DIMENSIONS ARE FROM GRID LIN
o. 7.	BEARING WEIGHT WILL BE PROVIDED AND INSTALLED BY OTHERS.		FACE OF WALL TO FINISHED FACE OF WALL OR CE OF COLUMN.
•	WALK-IN WALLS BEFORE INSTALLING CONCRETE FLOORS & CURBS. WALK-IN DOORS MUST BE LEFT OPEN WHILE INTERIOR CONCRETE WALK-IN FLOOR CURES - WHEN	7. 8.	ALL VERTICAL DIMENSIONS ARE FROM FINISHED F FINISHED TOP OF WALL OR WALL OPENING. ALL WALLS IN CONTACT WITH OR WITHIN 18" OF CO
		9.	EQUIPMENT SHALL BE CONSTRUCTED OF NON-CO MATERIALS AS PER LOCAL CODES. WHERE REQUIRED, SPRINKLER HEADS IN WALK-IN
	MECHANICAL NOTES	10.	WILL BE PROVIDED BY AND PROTECTED AGAINST I BY GENERAL CONTRACTOR. IT SHALL BECOME THE RESPONSIBILITY OF THE OV
1.	MECHANICAL EXHAUST SYSTEM TO BE PROVIDED OVER ALL COOKING EQUIPMENT AND OVER ALL DISHMACHINES WHERE APPLICABLE. PROVIDE MINIMUM OVERHANG AS REQUIRED BY ALL GOVERNING AGENCIES.	10.	ARCHITECT, ENGINEERS, AND/ OR GENERAL CONT INSURE THAT THE KITCHEN EQUIPMENT CONTRAC RECEIVES COPIES OF ALL ADDENDUMS AND CHAN BUILDING PLANS, PRIOR TO, OR DURING CONSTRU WHEREAS, ADDENDUMS AND/ OR CHANGES EFFEC
2.	MECHANICALLY INDUCED MAKE-UP AIR MUST BE PROVIDED FOR COOKING AND DISHWASHING EXHAUST SYSTEMS IN CONJUNCTION WITH H.V.A.C. SYSTEMS TO SUPPLY 100% OF EXHAUSTED AIR.	11.	AREA'S PERTINENT TO THE FOOD AND BEVERAGE STRUCTURAL ENGINEER OR GENERAL CONTRACT VERIFY STRUCTURAL INTEGRITY OF ROOF SUPPOR FOODSERVICE EQUIPMENT SUCH AS COMPRESSO EXHAUST AND MAKE-UP AIR SYSTEMS, EXHAUST H
3.	MECHANICAL CONTRACTOR TO VERIFY THE LOCATIONS OF THE EXHAUST AND MAKE-UP AIR DUCTS AT JOB SITE AND ADJUST AS REQUIRED BY FIELD CONDITIONS.	12.	GENERAL CONTRACTOR IS RESPONSIBLE TO PRO SEAL ALL NECESSARY PENETRATIONS (HOLES/ CH LINE RUNS THRU WALLS, FLOORS, CEILINGS, ROOI
4. 5.	BY A MINIMUM OF 10'-0" TO PREVENT RECIRCULATION OF AIR. ALL HORIZONTAL DUCT RUNS REQUIRE A MINIMUM OF 1/4"/FT.	13.	REQUIRED FOR ALL FOODSERVICE EQUIPMENT GENERAL CONTRACTOR TO PROVIDE ALL FIRE EXTINGUISHERS AS REQUIRED BY CODE NOT PRO
	SLOPE TOWARDS THE EXHAUST HOOD. VERIFY THIS REQUIREMENT WITH LOCAL CODES. GENERAL CONTRACTOR TO PROVIDE AND INSTALL ALL WALL		THE KITCHEN EQUIPIMENT CONTRACTOR.
			HEALTH DEPT. NOT
	REFRIGERATION NOTES	1.	ALL EQUIPMENT IS TO BE CONSTRUCTED AND INS THE REQUIREMENTS OF THE LOCAL HEALTH DEPA
1.	REFRIGERATION CONTRACTOR SHALL RUN ALL REFRIGERATION LINES WHICH EXTEND THRU WALLS BEFORE WALLS ARE CLOSED WHEN CONDUIT IS NOT PROVIDED BY GENERAL CONTRACTOR.		ACCEPTANCE OF THESE PLANS BY THE LOCAL HE. DEPARTMENT IS SUBJECT TO FINAL INSPECTION B AGENCY. OSWALT RESTAURANT SUPPLY ASSUME RESPONSIBLITY FOR ANY ADDITIONAL EQUIPMENT LABOR REQUIRED TO MEET ANY UNFORESEEN
2.	REFRIGERATION CONTRACTOR SHALL INSULATE ALL REFRIGERATION SUCTION LINES. REFRIGERATION CONTRACTOR SHALL VERIFY LOCATION OF	2.	REQUIREMENTS THAT MAY ARISE FROM THE INSPI ALL AREAS OF THE FOOD FACILTY SHALL BE PROV A MINIMUM OF 20 FOOT-CANDLES OF LIGHT, MEAS
3.	PITCH POCKET OR ROOF JACK FOR REFRIGERATION LINE PENETRATION THRU ROOF WITH GENERAL CONTRACTOR	3.	OFF THE FLOOR DURING GENERAL CLEAN UP ACT THE AIR SCREEN (WHEN REQUIRED) SHALL HAVE A VELOCITY OF 1600 FEET PER MINUTE, MEASURED
3.	GENERAL CONTRACTOR TO INSTALL PITCH POCKET OR ROOF JACK AND SEAL.		ABOVE THE GROUND, AND ACTIVATED VIA A DOOR
3.	GENERAL CONTRACTOR TO INSTALL PITCH POCKET OR ROOF	4.	ABOVE THE GROUND, AND ACTIVATED VIA A DOOR MICROSWITCH. ALL MOP SINK FAUCETS SHALL BE PROVIDED WITH THREADED OUTER LIP FOR HOSE ATTACHMENT AN
4.	GENERAL CONTRACTOR TO INSTALL PITCH POCKET OR ROOF JACK AND SEAL. ALL PENETRATIONS THRU ROOF TO BE DONE BY GENERAL CONTRACTOR. ROOF PENETRATIONS TO BE SEALED BY		MICROSWITCH. ALL MOP SINK FAUCETS SHALL BE PROVIDED WITH THREADED OUTER LIP FOR HOSE ATTACHMENT AN APPROVED BACKFLOW DEVISE. NO CHEMICAL DIS SYSTEMS SHALL BE ATTACHED TO THE MOP SINK
-	GENERAL CONTRACTOR TO INSTALL PITCH POCKET OR ROOF JACK AND SEAL. ALL PENETRATIONS THRU ROOF TO BE DONE BY GENERAL CONTRACTOR. ROOF PENETRATIONS TO BE SEALED BY ROOFING CONTRACTOR. GENERAL CONTRACTOR TO ALLOW MINIMUM OF 3'-0" CLEAR SPACE AROUND ROOF PAD FOR MAINTENANCE OR	5.	MICROSWITCH. ALL MOP SINK FAUCETS SHALL BE PROVIDED WITH THREADED OUTER LIP FOR HOSE ATTACHMENT AN APPROVED BACKFLOW DEVISE. NO CHEMICAL DIS SYSTEMS SHALL BE ATTACHED TO THE MOP SINK POT SINK TO HAVE TWO DRAINBOARDS MINIMUM 1 WITH THREE COMPARTMENTS LARGE ENOUGH TO LARGEST POT THAT WILL BE USED.
ι. 5.	GENERAL CONTRACTOR TO INSTALL PITCH POCKET OR ROOF JACK AND SEAL. ALL PENETRATIONS THRU ROOF TO BE DONE BY GENERAL CONTRACTOR. ROOF PENETRATIONS TO BE SEALED BY ROOFING CONTRACTOR. GENERAL CONTRACTOR TO ALLOW MINIMUM OF 3'-0" CLEAR SPACE AROUND ROOF PAD FOR MAINTENANCE OR CLEARANCE REQUIRED BY CODE. GENERAL CONTRACTOR TO PROVIDE AND INSTALL ROOF PAD. ROOF PAD TO BE A DETAILED BY THE ARCHITECT.		MICROSWITCH. ALL MOP SINK FAUCETS SHALL BE PROVIDED WITH THREADED OUTER LIP FOR HOSE ATTACHMENT AN APPROVED BACKFLOW DEVISE. NO CHEMICAL DIS SYSTEMS SHALL BE ATTACHED TO THE MOP SINK POT SINK TO HAVE TWO DRAINBOARDS MINIMUM 1 WITH THREE COMPARTMENTS LARGE ENOUGH TO
4.	GENERAL CONTRACTOR TO INSTALL PITCH POCKET OR ROOF JACK AND SEAL. ALL PENETRATIONS THRU ROOF TO BE DONE BY GENERAL CONTRACTOR. ROOF PENETRATIONS TO BE SEALED BY ROOFING CONTRACTOR. GENERAL CONTRACTOR TO ALLOW MINIMUM OF 3'-0" CLEAR SPACE AROUND ROOF PAD FOR MAINTENANCE OR CLEARANCE REQUIRED BY CODE. GENERAL CONTRACTOR TO PROVIDE AND INSTALL ROOF PAD. ROOF PAD TO BE A DETAILED BY THE ARCHITECT. REFRIGERATION CONTRACTOR TO SEAL ALL REFRIGERATION LINE PENETRATIONS MADE THRU WALK-IN COOLERS/ FREEZERS, AND REFRIGERATED BASE SECTIONS OF	5.	MICROSWITCH. ALL MOP SINK FAUCETS SHALL BE PROVIDED WITH THREADED OUTER LIP FOR HOSE ATTACHMENT AN APPROVED BACKFLOW DEVISE. NO CHEMICAL DIS SYSTEMS SHALL BE ATTACHED TO THE MOP SINK POT SINK TO HAVE TWO DRAINBOARDS MINIMUM 1 WITH THREE COMPARTMENTS LARGE ENOUGH TO LARGEST POT THAT WILL BE USED. ALL WALLS AND CEILING IN FOOD HANDLING AREA SMOOTH, NON-ABSORBENT, LIGHT IN COLOR, AND CLEANABLE AS DEFINED BY THE LOCAL HEALTH

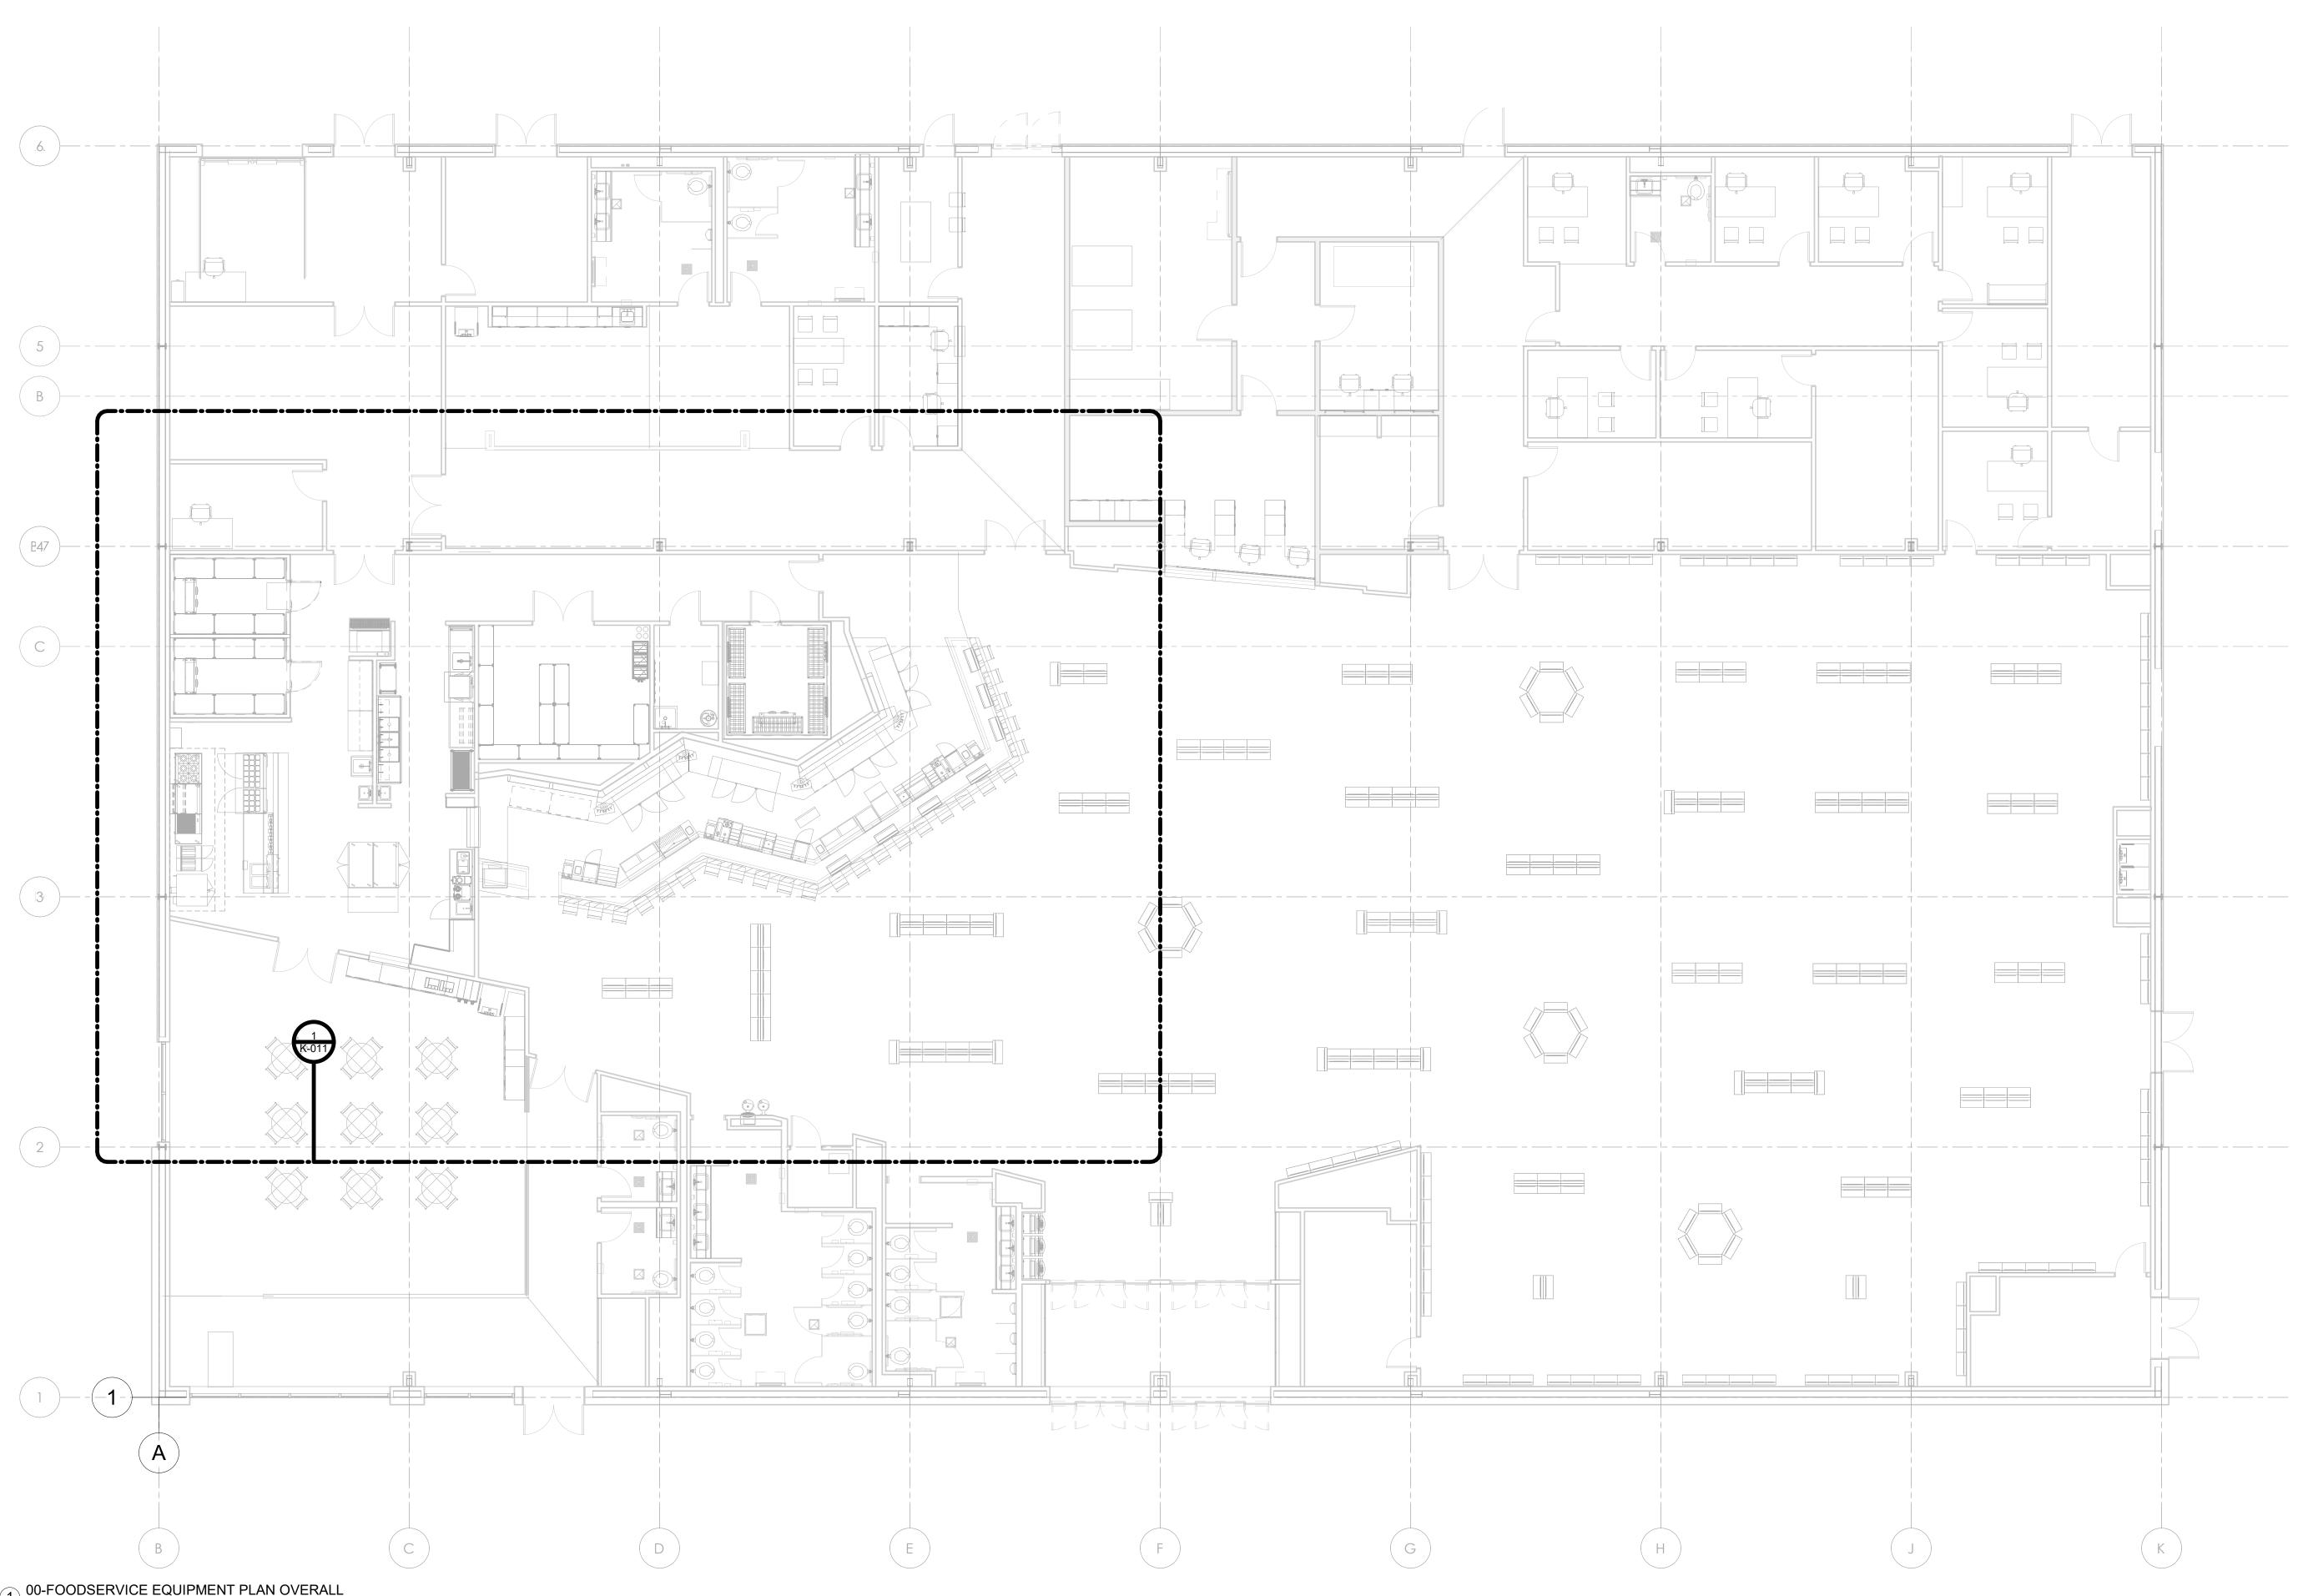
NO.	SHEET NAME
K-000	FOODSERVICE NOTES/ SHEET INDEX
K-010	FOODSERVICE OVERALL PLAN
K-011	FOODSERVICE EQUIPMENT PLAN
K-050	FOODSERVICE EQUIPMENT SCHEDULES / ABBREVIATION LEGEND
K-020	FOODSERVICE SPECIAL CONDITIONS PLAN
K-030	FOODSERVICE ELECTRICAL ROUGH-IN PLAN
K-040	FOODSERVICE PLUMBING IN-SLAB ROUGH-IN PLAN
K-041	FOODSERVICE PLUMBING ABOVE SLAB ROUGH-IN PLAN
K-060	FOODSERVICE DETAILS
K-070	FOODSERVICE KEY ELEVATION PLAN
K-071	FOODSERVICE ELEVATIONS
K-072	FOODSERVICE ELEVATIONS
K-080	FOODSERVICE WALK IN DETAILS
K-081	FOODSERVICE WALK IN DETAILS

#### S IN WALK-IN FREEZER D AGAINST FREEZING

# CURB & DEPRESSION NOTES

- GENERAL CONTRACTOR TO PROVIDE CONCRETE CURBS AND DEPRESSIONS WHEN REQUIRED
- 2. ALL CURB HEIGHTS ARE AS SHOWN ON PLAN. HEIGHTS SHOWN ARE FROM FINISHED FLOOR TO TOP OF FINISHED
- CURB. CURBS ARE TO BE NOTCHED A MINIMUM OF 3" AROUND 3. FLOOR SINKS.
- ALL DEPRESSIONS TO BE DEAD LEVEL AND DIMENSIONS ARE 4 FROM FINISHED FLOOR TO FINISHED SURFACE OF DEPRESSION.
- ALL CURB DIMENSIONS ARE TAKEN FROM FINISHED WALL TO FACE OF FINISHED CURB OR FROM FINISHED FACE OF CURB TO FINISHED FACE OF CURB. 5.
- ALL CURBS THAT ARE TO RECEIVE EQUIPMENT AND/ OR 6. FIXTURES TO BE FINISHED SMOOTH AND LEVEL AND INTERSECTION OF TOP OF CURB AT FINISHED WALL TO BE FINISHED SQUARE (NOT COVED).
- GENERAL CONTRACTOR TO INSTALL INTEGRAL FINISH FLOOR 7. COVE BASE PRIOR TO THE INSTALLATION OF THE FOODSERVICE EQUIPMENT.

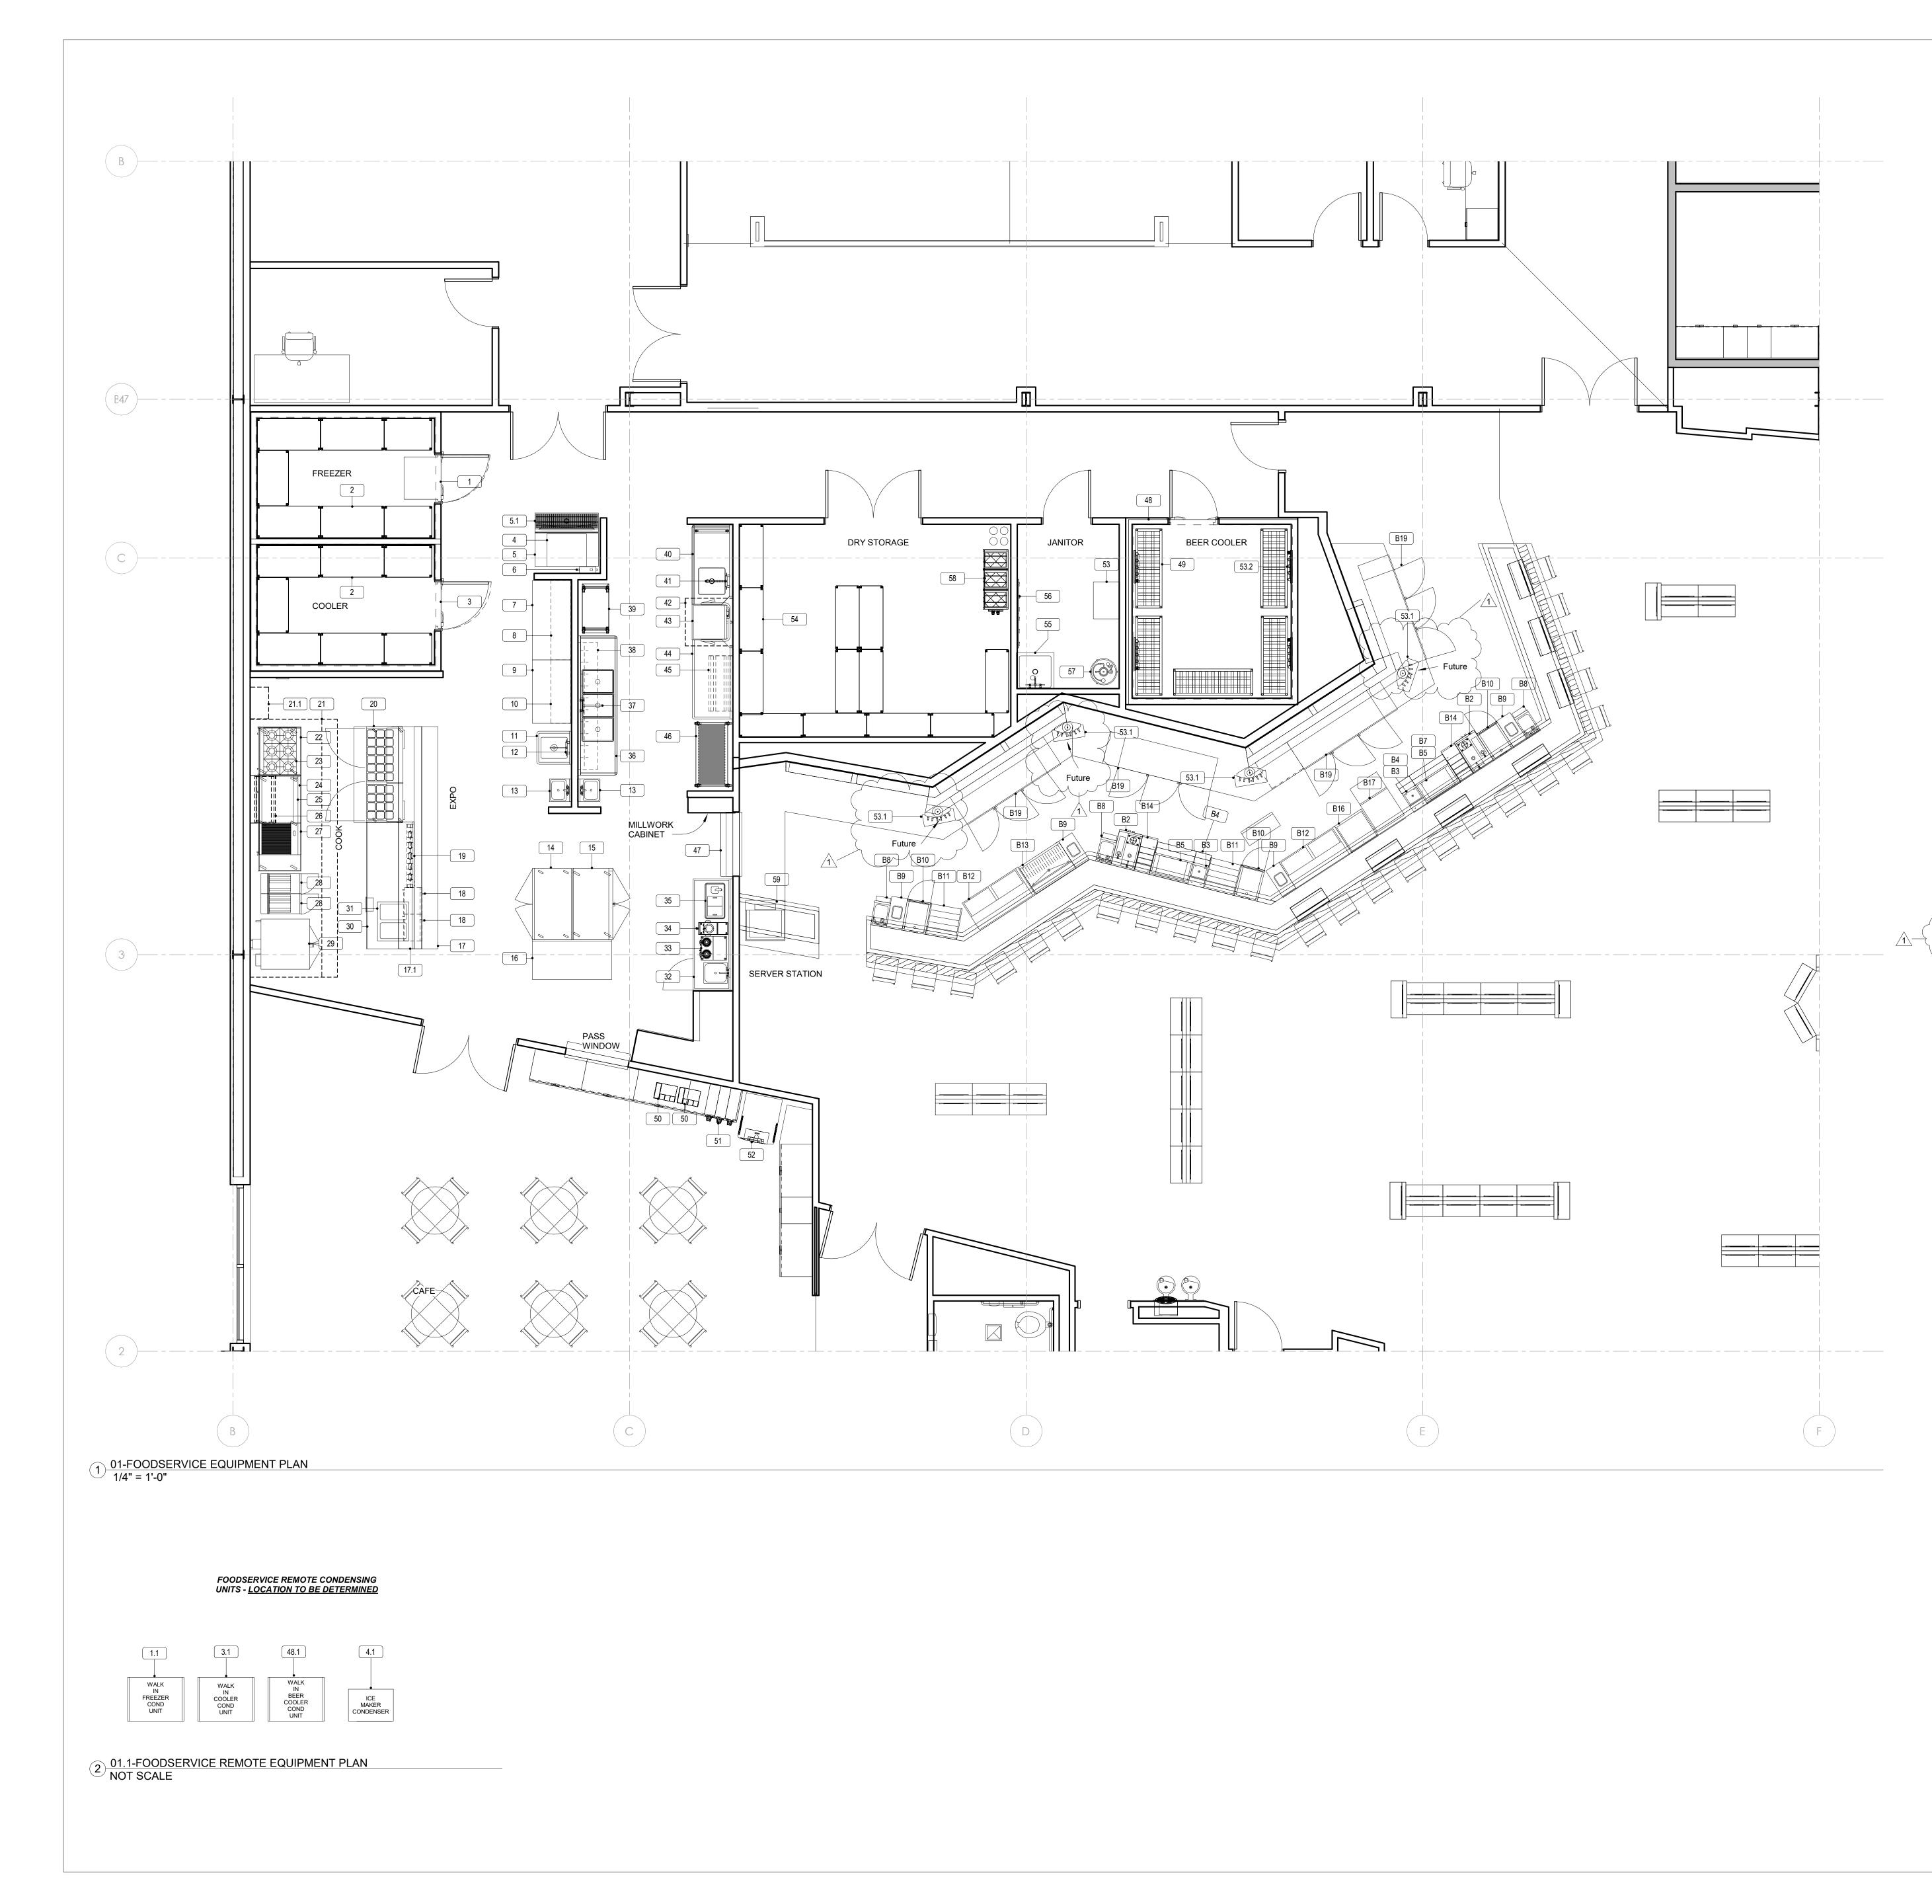
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Rev	Description	Date
Project Title:		
	HOBART, OKLAHOMA	
	HOBART, OKLAHOMA	
Sheet Title:	ERVICE NOTES	S/ SHEET
Sheet Title:	ERVICE NOTES INDEX 24	S/ SHEET 1/4" = 1'-0"
Sheet Title: FOODS	ERVICE NOTES INDEX 24 Scale: Sheet No.	



1 00-FOODSERVICE EQUIPMENT PLAN OVERALL 1/8" = 1'-0"

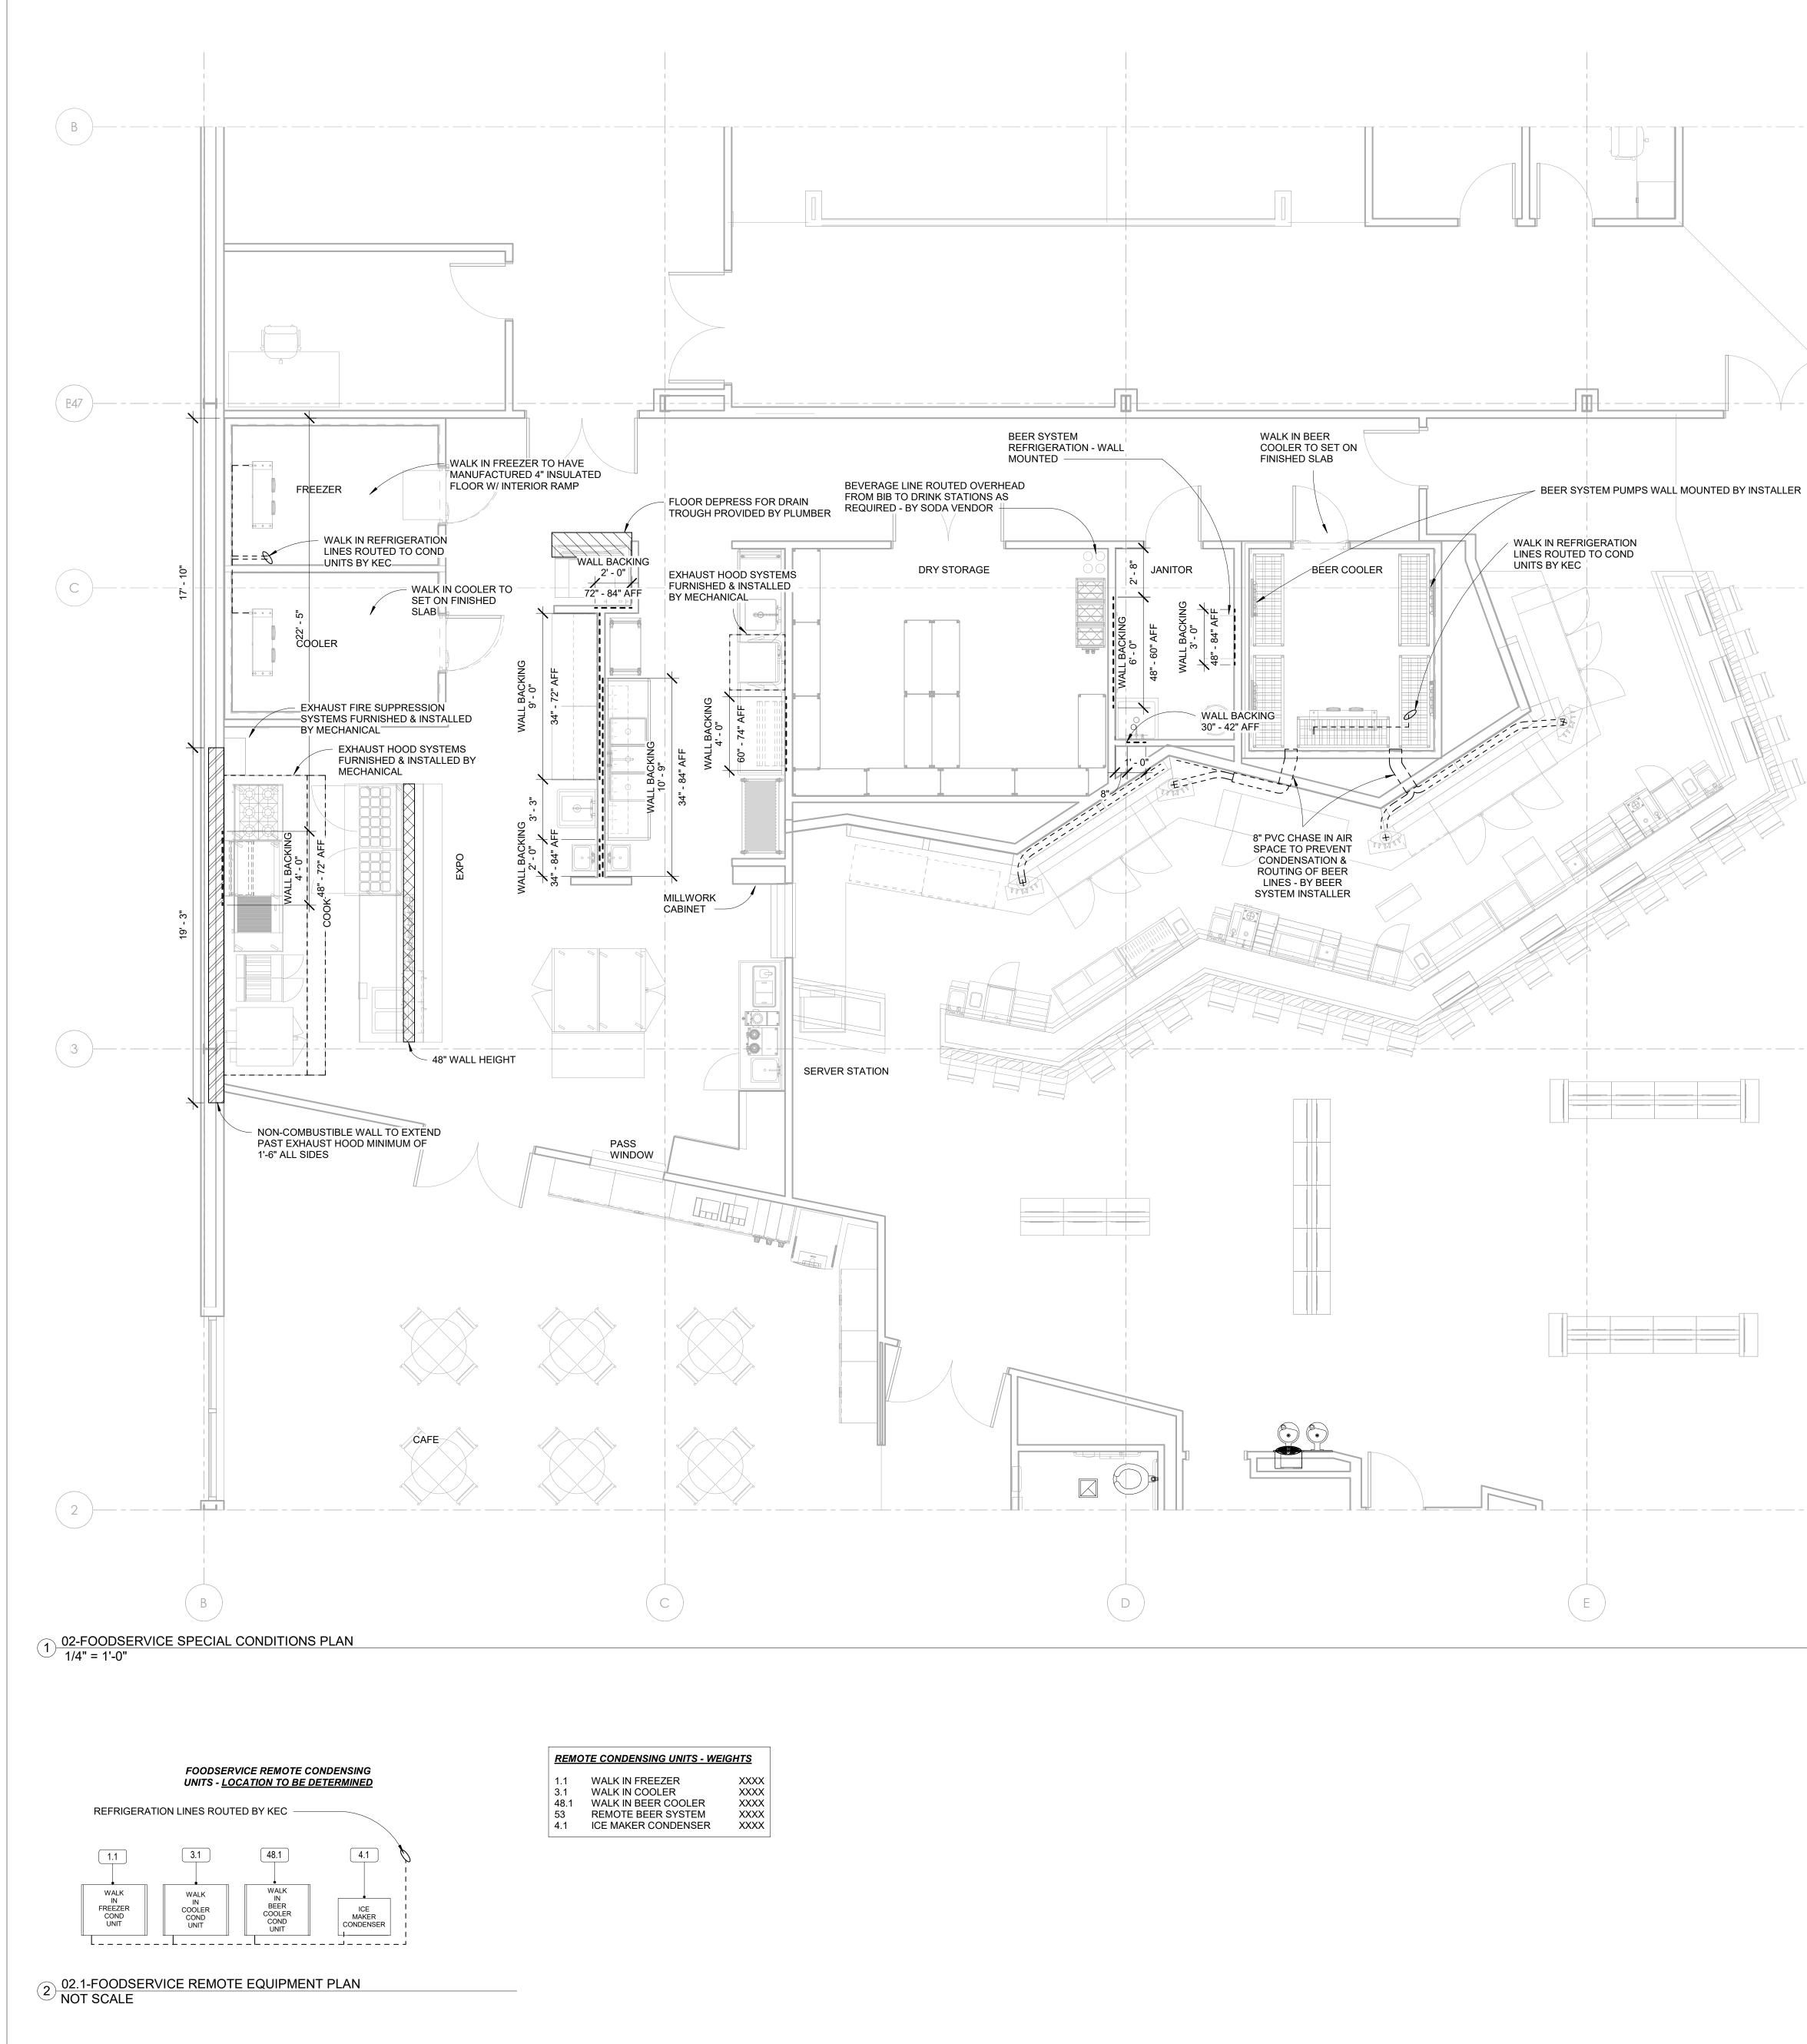
<b>OS</b>	WALT
Oklahor	Enterprise Drive na City, OK 73128 E 405-843-9000
Rev	Description Date
Project Title:	
KIOWA CASINO	HOBART, OKLAHOMA
Sheet Title:	VICE OVERALL PLAN
Date: Jan. 17, 2024 Drawn By: OSW	Scale: 1/8" = 1'-0" Sheet No.
Check By: N/A	<b>K-010</b>

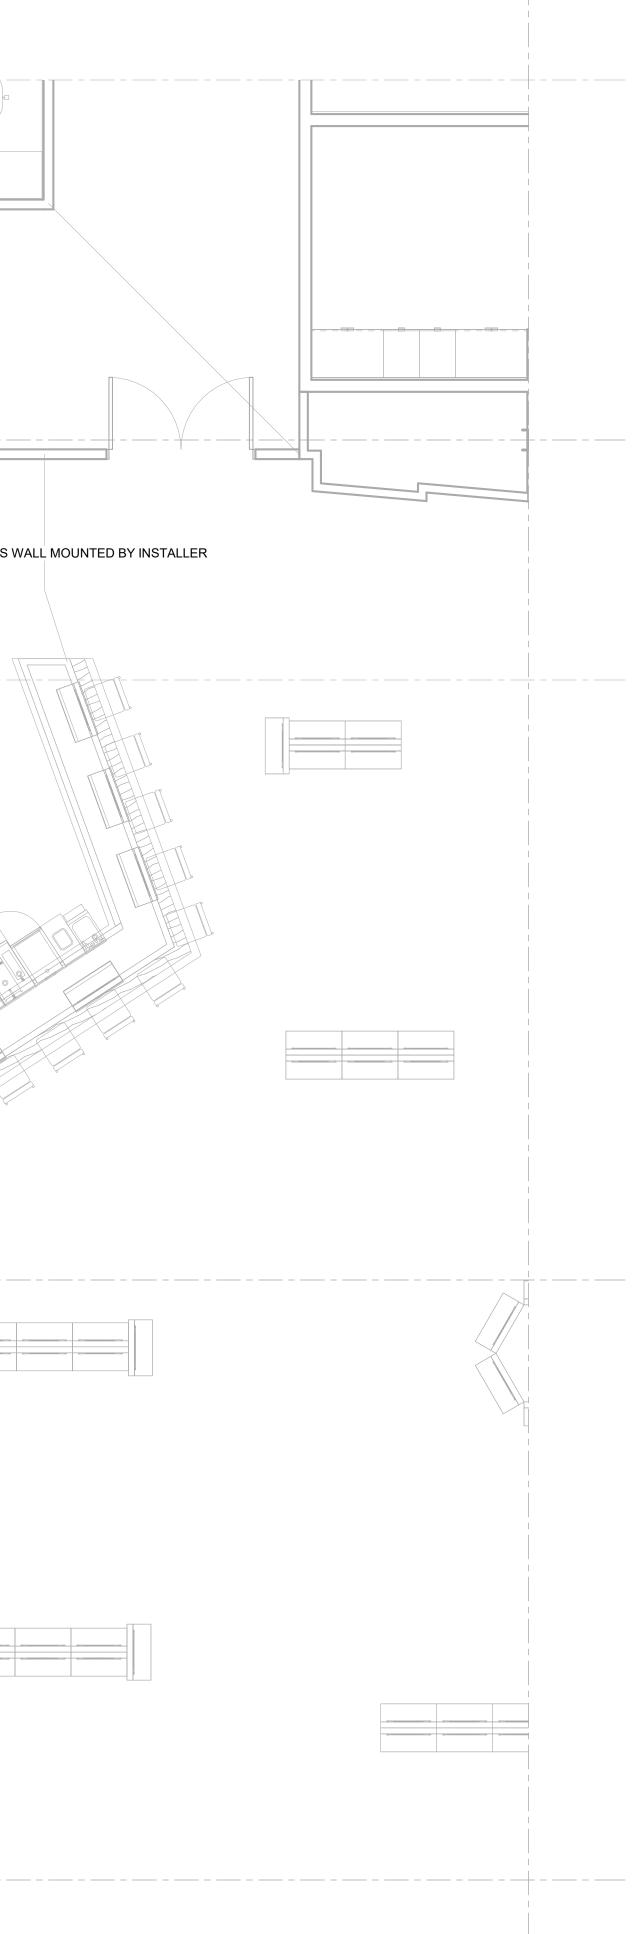
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17		
ITEM 1	DESCRIPTION WALK IN FREEZER	Comments
1.1	WALK IN FREEZER COND UNIT	
1.2	WALK IN FREEZER EVAPORATOR	
2	COLD STORAGE SHELVING	
2		
-		
3.1	WALK IN COOLER COND UNIT	
3.2	WALK IN COOLER EVAPORATOR	
4	ICE MACHINE - 1400 LBS/ CUBE/ REMOTE	
4.1	ICE MAKER CONDENSER	
5	970 LB ICE BIN	
5.1	FLOOR TROUGH - BY PLUMBER	
6	ICE MACHINE FILTER	
7	STAINLESS WORK TABLE	
8	WALL SHELF	
9	STAINLESS WORK TABLE	
10	WALL SHELF	
11	PREP SINK	
12	FAUCET	
13	HAND SINK	
14	REACH IN SOLID DOOR FREEZER	
15	REACH IN GLASS DOOR COOLER	
16	STAINLESS WORK TABLE	
17	DISH CABINET	
17.1	DUAL PASS-THRU SHELF	
18	MICROWAVE OVEN	
19	FOOD WARMER	
20	SANDWICH/ SALAD UNIT	
21	EXHAUST HOOD - BY MECHANICAL	
21.1	FIRE SUPPRESSION - BY MECHANICAL (VERIFY	
	LOCATION)	
22	REFRIGERATED DRAWERS	
23	SIX OPEN BURNERS	
24	REFRIGERATED DRAWERS	
25	48" GRIDDLE	
26	48" CHEESE MELTER	
27	24" CHAR GRILL	
28	FRYER	
29	CONVECTION OVEN - SINGLE	
30	CHEF COUNTER	
31	DROP IN HOT FOOD WELLS	
32	BEVERAGE COUNTER	
33	COFFEE BREWER - BY OWNER	
34	TEA BREWER - BY OWNER	
35	DROP IN WATER/ ICE STATION	
36	SINK, THREE COMPARTMENT	
37	FAUCET	
38	SHELF W/ POT RACK HOOKS	
39	BUSSING CART	
40	DISHTABLE,SOILED	
41	PRE-RINSE W/ ADD ON FAUCET	
42	EXHAUST HOOD - BY MECHANICAL	
42	DISHWASHING MACHINE	
44	CLEAN STRAIGHT DISHTABLE	
45	DISHTABLE SORTING SHELF	
46	MOBILE DISH DRYING RACK	
47	STAINLESS PASS SHELF	
48		
48.1		
48.2	WALK IN BEER COOLER EVAPORATOR	
49	BEER STORAGE RACK	
50	CONDIMENT DISPENSERS -BY OWNER	
51		
52	FREESTYLE COKE MACHINE - BY OWNER	
53	RÉMOTE BEER SYSTEM V V V	Y Y
53.1	BEER TOWER - 6 TAPS EACH	(3) Three units to be Future
53.2		
_54	DRY STORAGE SHELVING	
55	MOP SINK W/ FAUCET & MOP HOLDERS	
56	WALL MOUNT MOP HOLDERS	
57	C02 TANK - BEER SYSTEM	
58	BAG 'N BOX RACK - BY OWNER	
59	ICE BEVERAGE DISPENSER - BY OWNER	
B2	BAR SINK STATION W/ GLASS RINSER	
B3	BOTTLE WELL W/ SODA GUN HOUSING	
B4	UNDERBAR SPEED RAIL	
B5	30" ICE BIN	
B7	UNDERBAR SPEED RAIL	
B8	BAR HAND SINK	
B9	TRASH	
-	POS CABINET	
B10	LIQUOR DISPLAY	
B10 B11	GLASS CHILLER	
B11		
B11 B12		
B11 B12 B13		
B11 B12 B13 B14	LIQUOR DISPLAY	
B11 B12 B13 B14 B15	LIQUOR DISPLAY SPARE NUMBER	
B11 B12 B13 B14 B15 B16	LIQUOR DISPLAY SPARE NUMBER DRAINBOARD W/ GLASS RACKS	
B11 B12 B13 B14 B15	LIQUOR DISPLAY SPARE NUMBER	

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1	Revision 1		01/17/24
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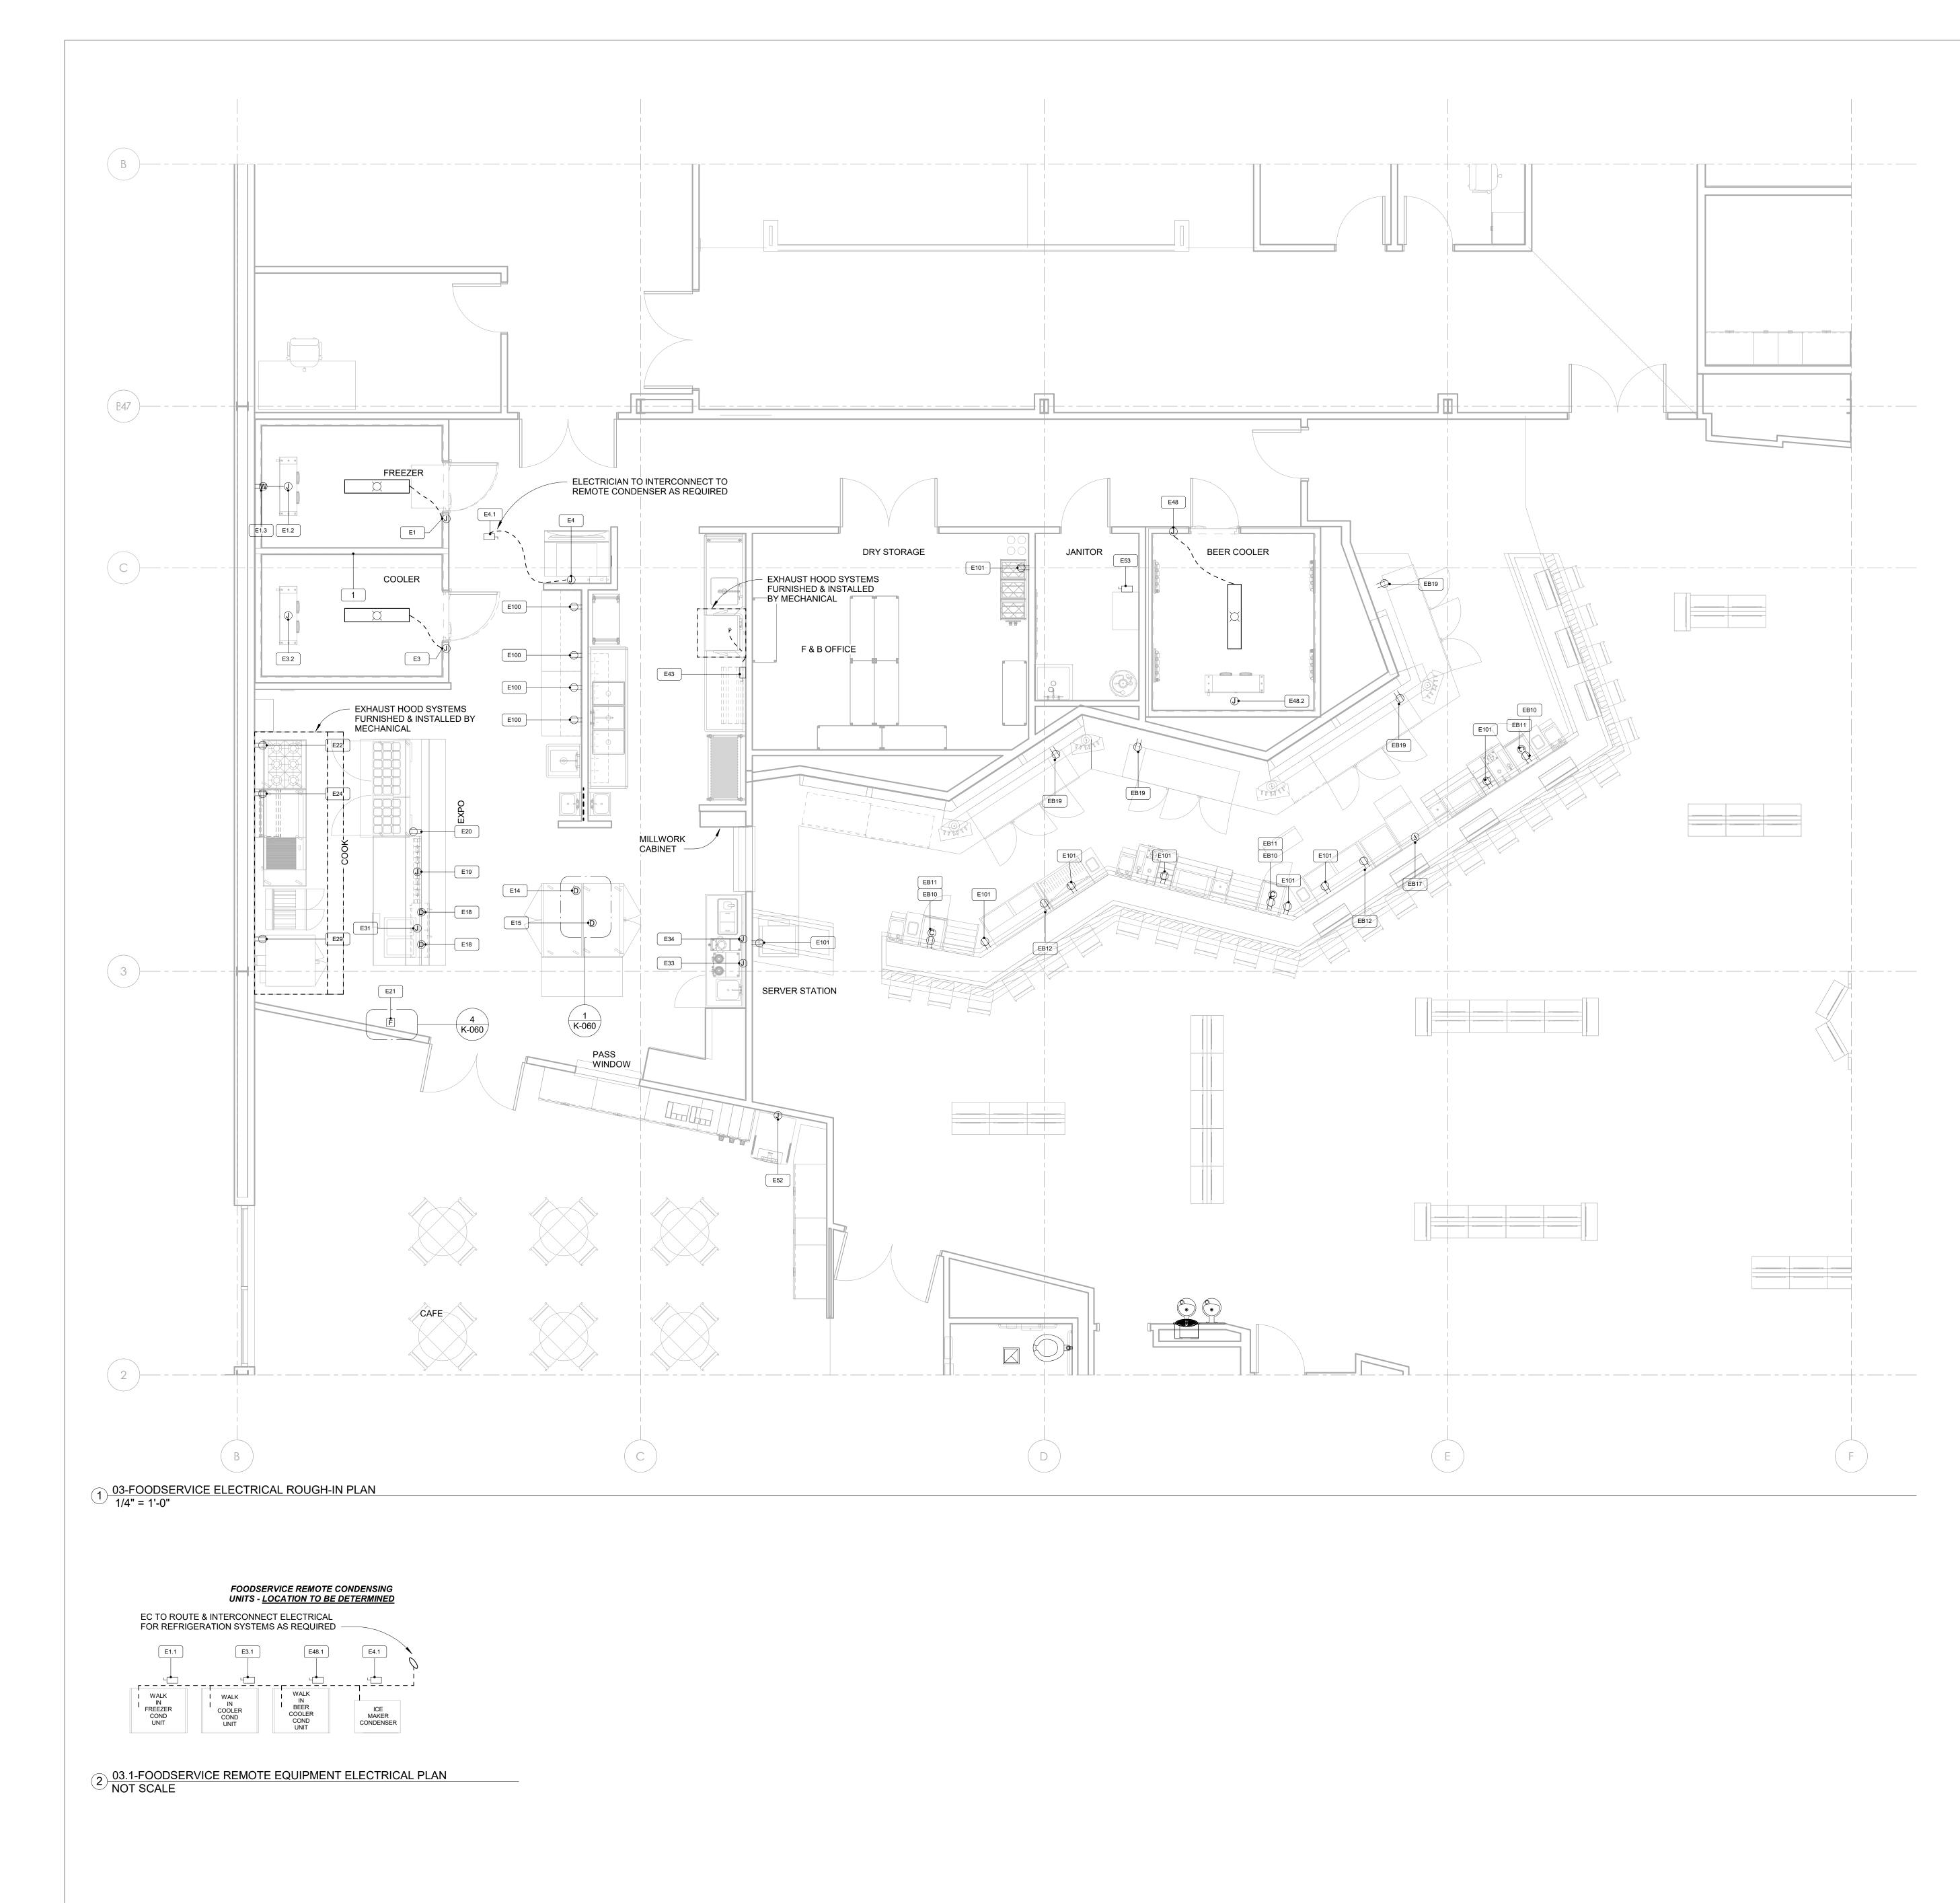
#### SPECIAL CONDITION NOTES BEVERAGE LINES - THE G.C. IS TO PROVIDE A 6" DIA. PVC CHASE BELOW THE FLOOR FOR THE BEVERAGE LINES. PROVIDE ELBOWS WITH A 30" MINIMUM DIAMETER RADIUS AT ALL CHASE TURNS. STUB-UP 6" AT EACH END OF THE CHASE. THE CHASE IS TO BE WATERTIGHT WHEN KITCHEN EQUIPMENT CONTRACTOR IS SPECIFICALLY REQUIRED TO HANG EXHAUST HOODS THEY WILL PROVIDE HANGER ROD SUPPORTS TO MAXIMUM OF + 6'-0" ABOVE HOOD TO SUPPORT STRUCTURE ABOVE PROVIDED BY OTHERS. SUPPORTS AND CONNECTIONS TO STRUCTURE TO BE BY STRUCTURAL ENGINEER OF RECORD AND NOT INCLUDED IN THE KITCHEN EQUIPMENT CONTRACTORS SCOPE. GENERAL CONTRACTOR TO PROVIDE AND INSTALL NON-COMBUSTIBLE WALL REQUIRED AT EXHAUST HOOD LOCATIONS TO EXTEND A MINIMUM OF 18" IN ALL DIRECTIONS. 4. ALL DIMENSIONS INDICATED ARE FROM FINISHED SURFACES UNLESS SPECIFICALLY STATED OTHERWISE. GENERAL CONTRACTOR TO PROVIDE ALL WALL BACKING REQUIRED FOR FOODSERVICE EQUIPMENT. ANY ATTACHMENT TO BUILDING STRUCTURE FOR LOAD BEARING WEIGHT WILL BE PROVIDED AND INSTALLED BY OTHERS. GENERAL CONTRACTOR TO INSTALL PROTECTIVE COVER ON WALK-IN WALLS BEFORE INSTALLING CONCRETE FLOORS & CURBS. WALK-IN DOORS MUST BE LEFT OPEN WHILE INTERIOR CONCRETE WALK-IN FLOOR CURES - WHEN APPLICABLE.

### **BUILDING CONDITIONS / VENTILATION SYMBOLS**

	WALL BACKING FLOOR DEPRESSION
	NON-COMBUSTIBLE WALL
	EXHAUST DUCT
	EXHAUST DUCT
	MAKE-UP AIR DUCT
	SUPPLY DUCT
$\bigcirc$	BEVERAGE CONDUIT
	UTILITY CURB
	REFRIGERATION PAD
	FULL HEIGHT WALL
$\bigcirc$	GRAVITY EXHAUST CONNECTION
]-1	FIRE PULL STATION
60	REFRIGERATION LINE CHASE
<u> </u>	4" MIN. DIA. UNDER SLAB REFRIGERATION LINES.

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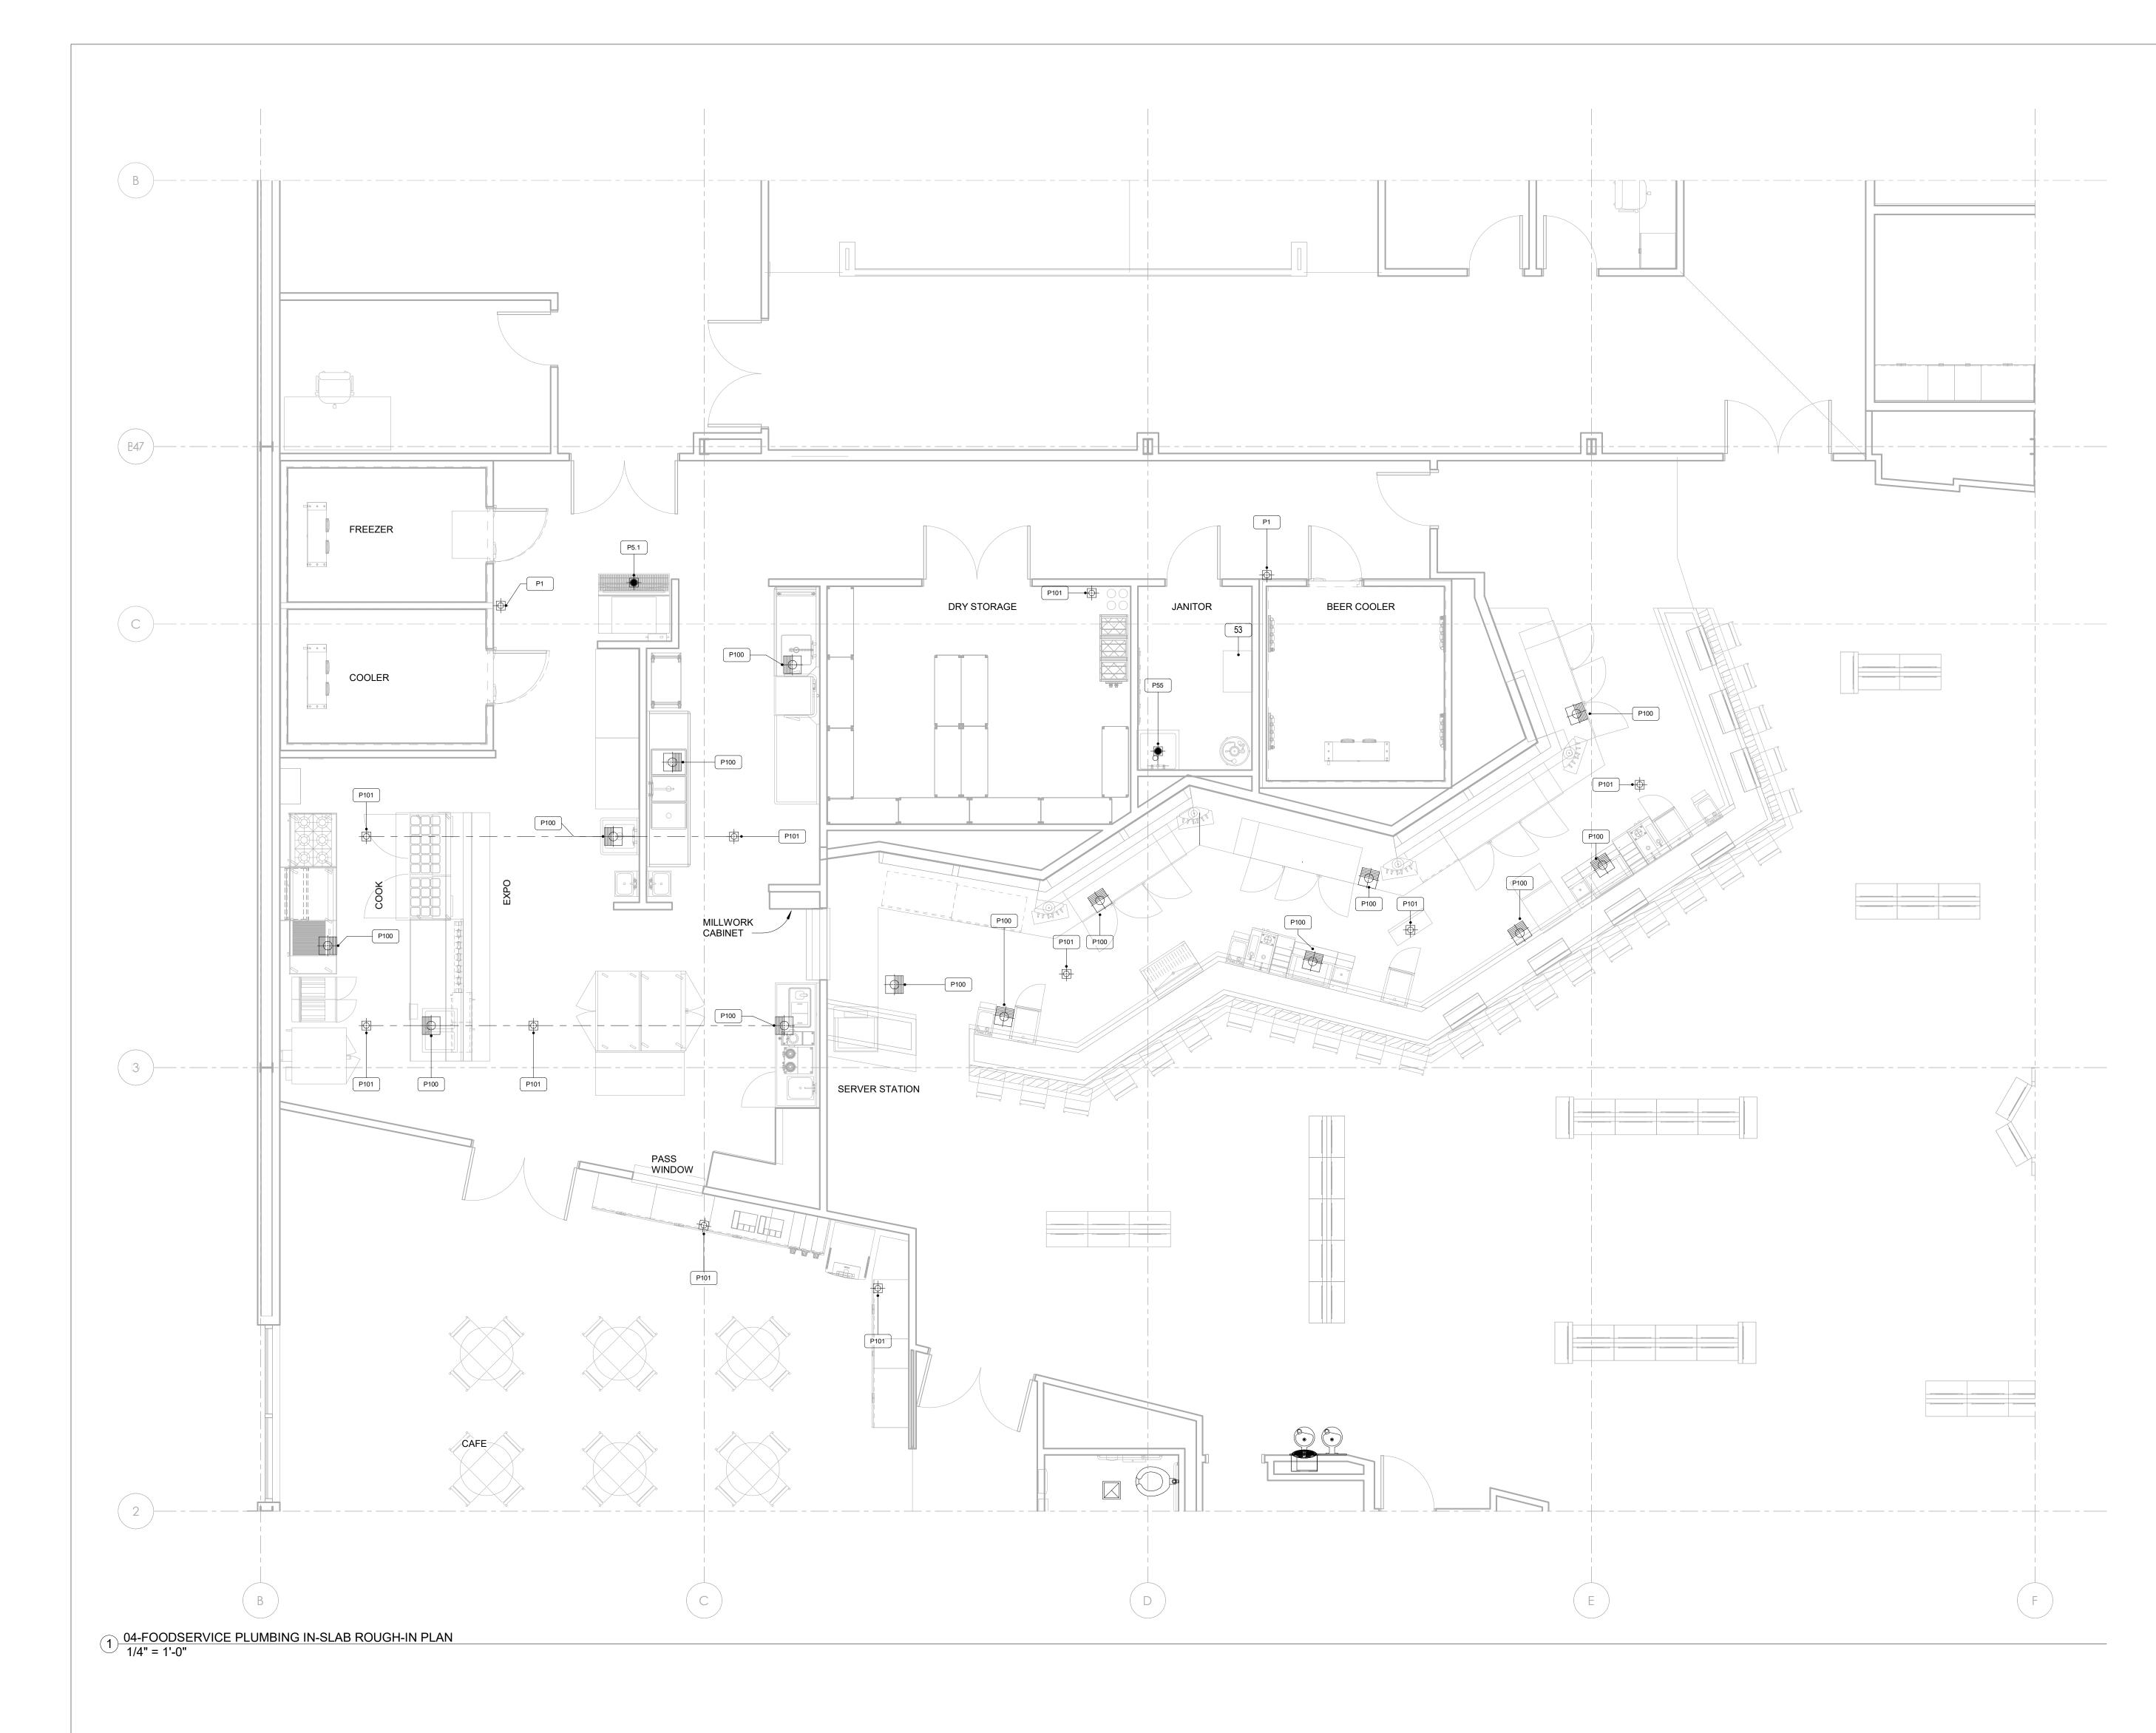


	ELECTRICAL LEGEND
	DUPLEX RECEPTACLE
$\rightarrow$	SINGLE RECEPTACLE
-	SPECIAL PURPOSE RECEPTACLE
Ø	FLUSH FLOOR MOUNT RECEPTACLE
J	JUNCTION BOX - FLOOR/ CLG MOUNTED
J	JUNCTION BOX - WALL MOUNTED
S	SWITCH
	DATA CONNECTION
F	FIRE PULL STATION
D	DROP CORD FROM CEILING
C	CONDUIT STUB
	DISCONNECT SWITCH
X	VAPOR PROOF LIGHT
$\sim$	MOTOR
	WEATHERPROOF RECEPTACLE
101	ITEM NO TAG. (REFER K-020)

	ELECTRICAL NOTES (DIV. 26)
1.	ELECTRICAL CONNECTIONS INDICATED ARE THOSE REQUIRED FOR THE FOODSERVICE EQUIPMENT. FOR ADDITIONAL REQUIREMENTS REFER TO ELECTRICAL ENGINEER'S DRAWINGS
2.	DIMENSIONS INDICATED ARE TO BE VERIFIED BY EC AND ADJUSTED AS REQUIRED.
3.	ACCESSORIES AND FITTINGS PROVIDED LOOSE WITH FOODSERVICE EQUIPMENT BY K.E.C. TO BE INSTALLED BY EC.
4.	ELECTRICAL CONTRACTOR TO CONNECT EXHAUST HOOD LIGHT(S) AND EXHAUST FAN(S) / MAKE-UP AIR UNIT(S) AS REQUIRED. INTERWIRE HOOD SECTIONS, MOTOR STARTER(S) / DRIVES AND OVERLOAD PROTECTION AS REQUIRED. INSTALL COMPONENTS AND SENSORS SHIPPED LOOSE (REFER TO SYSTEM SHOP DRAWING(S) FOR ADDITIONAL INFORMATION.
5.	ELECTRICAL CONTRACTOR TO CONNECT KITCHEN EQUIPMENT CONTRACTOR FURNISHED TEMPERATURE ALARM SYSTEM AND COORDINATE WITH BUILDING ALARM SYSTEM.
6.	ELECTRICAL CONTRACTOR TO CONNECT KITCHEN EQUIPMENT CONTRACTOR FURNISHED CONDENSING UNIT AND THRU DEFROST TIMER TO EVAPORATOR COIL.
7.	ELECTRICAL CONTRACTOR TO FURNISH AND INSTALL WIF DRAIN HEATER.
8.	ELECTRICAL CONTRACTOR TO CONNECT 120 VOLT FROM KITCHEN EQUIPMENT CONTRACTOR FURNISHED MICRO SWITCH IN FIRE SUPPRESSION SYSTEM CONTROL PANEL THRU MANUAL RESET RELAY TO ELECTRICAL GAS VALVE. PROVIDE CONTROL/ INTERWIRING BETWEEN THE FIRE SUPPRESSION SYSTEM AND ASSOCIATED ELECTRICAL GAS SOLENOID VALVES, RESET RELAYS AND PULL STATIONS AS REQUIRED.
9.	ELECTRICAL CONTRACTOR TO FURNISH AND INSTALL CONCEALED CONDUIT AND RECESSED OCTAGONAL JUNCTION BOX IN WALL AT 42"-48" A.F.F. FOR REMOTE MANUAL PULL STATION(S). COORDINATE LOCATION(S) WIRE FIRE SUPPRESSION SYSTEM CONTRACTOR AND AUTHORITIES HAVING JURISDICTION PRIOR TO ROUGH-IN.
10.	ELECTRICIAN TO REFERENCE/COORDINATE ALL INFORMATION SHOWN ON THE FOODSERVICE DRAWINGS WITH ELECTRICAL ENGINEERING PLANS AND DOCUMENTS

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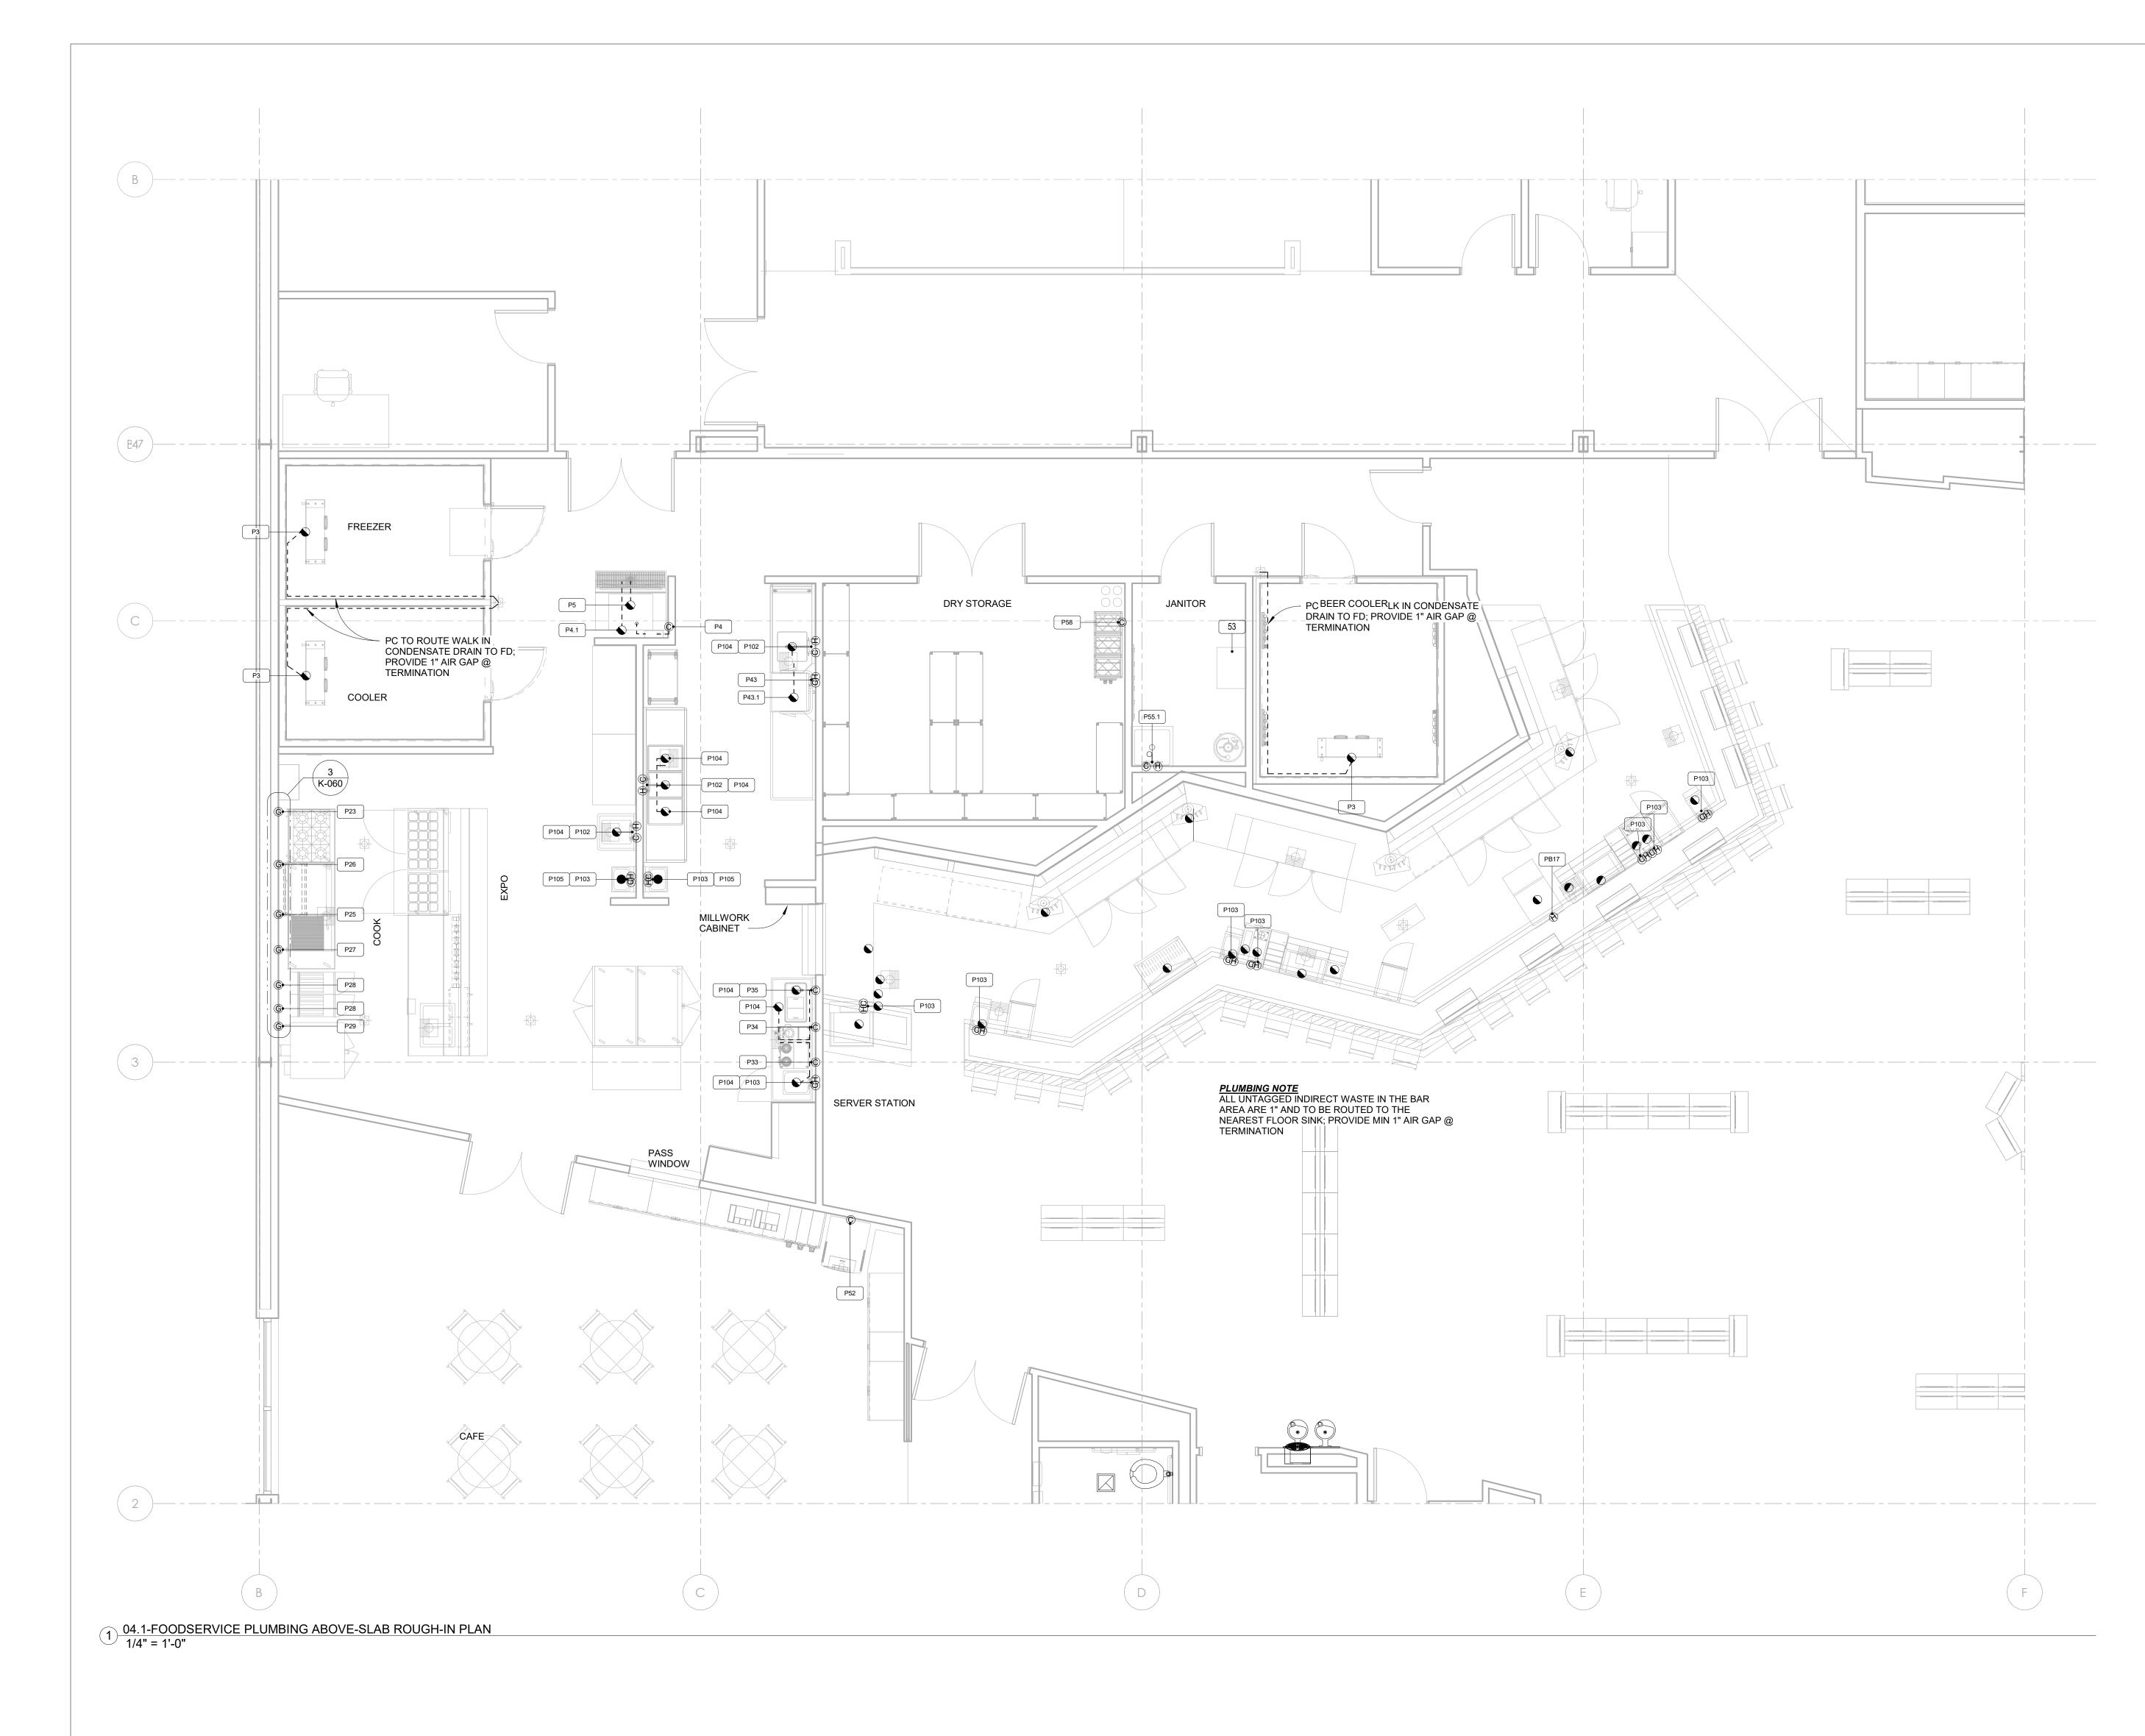


	PLUMBING LEGEND						
©	COLD WATER						
Ē	COLD - FILTERED WATER						
θ	HOT WATER						
	DIRECT WASTE						
	FLOOR SINK - THREE QUARTER GRATE						
	FLOOR SINK - PARTIAL GRATE						
	FLOOR SINK - NO GRATE						
	FLOOR DRAIN						
	FUNNEL FLOOR DRAIN						
-	HUB FLOOR DRAIN						
G	GAS FROM MANIFOLD						
	FIRE SUPPRESSION GAS SHUT OFF VALVE						
	INDIRECT WASTE						
101	ITEM NO TAG. (REFER K-020)						

	Ρ	LUMBING NOTES (DIV. 22)
1	IN TI A	ATER & DRAIN CONNECTIONS IDICATED ARE THOSE REQUIRED FOR HE FOODSERVICE EQUIPMENT. FOR DDITIONAL REQUIREMENTS REFER TO LUMBING ENGINEER'S DRAWINGS
2	C C	RAINAGE AND PIPING SYSTEMS TO BE LEANED BY PC PRIOR TO FINAL ONNECTION TO FOODSERVICE QUIPMENT.
3	Т	NGINEER TO VERIFY W/ LOCAL CODE O BYPASS OR PIPE THRU GREASE TRAP ND/OR INTERCEPTOR.
4	G H E	'W.C. AT EQUIPMENT. MECHANICAL AS SHUT-OFF VALVE FURNISHED BY OOD SUPPLIER. FINAL CONNECTION TO QUIPMENT AND INSTALLATION OF ECHANICAL GAS VALVE BY G.C.
5	В	LL EXPOSED FIRE SYSTEM PIPING TO E CHROME PLATED OR STAINLESS TEEL.
6	A S A A C W A C W A C W A N W A N	ROTECTIVE DEVICES TO PROTECT GAINST BACK FLOW. BACK SYPHONAGE HALL BE INSTALLED AT ALL FIXTURES ND EQUIPMENT WHERE BACKFLOW ND/OR BACKSYPHONAGE MAY OCCUR ND WHERE A MINIMUM AIR GAP ANNOT BE PROVIDED BETWEEN THE /ATER TO THE FIXTURE OR EQUIPMENT ND ITS FLOOD/LEVEL RIM. TO BE ROVIDED AND INSTALLED BY PC. ACUUM BREAKERS, WHEN FURNISHED /ITH EQUIPMENT SHALL OVERRIDE BOVE, IF ACCEPTABLE WITH PPLICABLE CODES, BUT PC TO PIPE /HEN NOT PREPIPED BY FACTORY. ITERCONNECT THRU WATER FILTER TO QUIPMENT BY PC.
7	. B	ACKFLOW PREVENTION BY PC.
8	. IN	ISTALL KEC FURNISHED MOP SINK(S).
9		LL FLOOR SINKS TO BE FLUSH WITH INISHED FLOOR.
1	IN	LUMBING CONTRACTOR TO ITERCONNECT FILTERED WATER TO ICE ACHINE FROM ICE MACHINE FILTER.
1	IN C	LUMBING CONTRACTOR TO ITERCONNECT FILTERED WATER TO OOKING EQUIP AND BEVERAGE EQUIP - EQUIREMENTS AS STATED ON PLANS.
1	T	ANITOR'S FAUCET TO HAVE A HREADED OUTER LIP FOR HOSE TTACHMENT.
1	D	LUMBING CONTRACTOR TO WRAP WIF RAIN LINE WITH HEAT RIBBON TO REVENT LINE FROM FREEZING.
1	A F A	LUMBER TO REFERENCE/COORDINATE LL INFORMATION SHOWN ON THE OODSERVICE DRAWINGS WITH RCHITECTURAL AND PLUMBING NGINEERING PLANS.
1	S	EFER TO SHEET <b>K-000</b> FOR ALL NOTES, YMBOLS, ETC. PERTAINING TO THIS ROJECT.

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FOODSERVIC ROU Date: Jan. 17, 2024	GH-IN PLAN	IN-SLAB 4" = 1'-0"				
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	PLUMBING LEGEND						
C	COLD WATER						
© COLD - FILTERED WATER							
H	HOT WATER						
	DIRECT WASTE						
	FLOOR SINK - THREE QUARTER GRATE						
FLOOR SINK - PARTIAL GRATE							
	FLOOR SINK - NO GRATE						
-	FLOOR DRAIN						
-	FUNNEL FLOOR DRAIN						
	HUB FLOOR DRAIN						
G	GAS FROM MANIFOLD						
	FIRE SUPPRESSION GAS SHUT OFF VALVE						
	INDIRECT WASTE						
101	ITEM NO TAG. (REFER K-020)						

	PLUMBING NOTES (DIV. 22)
1.	WATER & DRAIN CONNECTIONS INDICATED ARE THOSE REQUIRED FOR THE FOODSERVICE EQUIPMENT. FOR ADDITIONAL REQUIREMENTS REFER TO PLUMBING ENGINEER'S DRAWINGS
2.	DRAINAGE AND PIPING SYSTEMS TO BE CLEANED BY PC PRIOR TO FINAL CONNECTION TO FOODSERVICE EQUIPMENT.
3.	ENGINEER TO VERIFY W/ LOCAL CODE TO BYPASS OR PIPE THRU GREASE TRAP AND/OR INTERCEPTOR.
4.	6" W.C. AT EQUIPMENT. MECHANICAL GAS SHUT-OFF VALVE FURNISHED BY HOOD SUPPLIER. FINAL CONNECTION TO EQUIPMENT AND INSTALLATION OF MECHANICAL GAS VALVE BY G.C.
5.	ALL EXPOSED FIRE SYSTEM PIPING TO BE CHROME PLATED OR STAINLESS STEEL.
6.	PROTECTIVE DEVICES TO PROTECT AGAINST BACK FLOW. BACK SYPHONAGE SHALL BE INSTALLED AT ALL FIXTURES AND EQUIPMENT WHERE BACKFLOW AND/OR BACKSYPHONAGE MAY OCCUR AND WHERE A MINIMUM AIR GAP CANNOT BE PROVIDED BETWEEN THE WATER TO THE FIXTURE OR EQUIPMENT AND ITS FLOOD/LEVEL RIM. TO BE PROVIDED AND INSTALLED BY PC. VACUUM BREAKERS, WHEN FURNISHED WITH EQUIPMENT SHALL OVERRIDE ABOVE, IF ACCEPTABLE WITH APPLICABLE CODES, BUT PC TO PIPE WHEN NOT PREPIPED BY FACTORY. INTERCONNECT THRU WATER FILTER TO EQUIPMENT BY PC.
7.	BACKFLOW PREVENTION BY PC.
8.	INSTALL KEC FURNISHED MOP SINK(S).
9.	ALL FLOOR SINKS TO BE FLUSH WITH FINISHED FLOOR.
10.	PLUMBING CONTRACTOR TO INTERCONNECT FILTERED WATER TO ICE MACHINE FROM ICE MACHINE FILTER.
11.	PLUMBING CONTRACTOR TO INTERCONNECT FILTERED WATER TO COOKING EQUIP AND BEVERAGE EQUIP - REQUIREMENTS AS STATED ON PLANS.
12.	JANITOR'S FAUCET TO HAVE A THREADED OUTER LIP FOR HOSE ATTACHMENT.
13.	PLUMBING CONTRACTOR TO WRAP WIF DRAIN LINE WITH HEAT RIBBON TO PREVENT LINE FROM FREEZING.
14.	PLUMBER TO REFERENCE/COORDINATE ALL INFORMATION SHOWN ON THE FOODSERVICE DRAWINGS WITH ARCHITECTURAL AND PLUMBING ENGINEERING PLANS.
15.	REFER TO SHEET <b>K-000</b> FOR ALL NOTES, SYMBOLS, ETC. PERTAINING TO THIS PROJECT.

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### ABBREVIATIONS

FOOL			LECTRICAL SCHEDULE
IOOL			
	LOCATION	AFF	REMARKS
rs	ABOVE		EC TO INTERCONNECT AS REQUIRED; 48" LED FIXTURE PROVIDED BY KEC
DUNIT	TBD		EC TO INTERCONNECT AS REQUIRED
ORATOR	ABOVE		EC TO INTERCONNECT AS REQUIRED
TAPE	WALL	48"	EC TO FURNISH & INSTALL WEATHERPROOF RECEPTACLE TO SERVICE THE FREEZER HEAT TAPE.
S	ABOVE		EC TO INTERCONNECT AS REQUIRED; 48" LED FIXTURE PROVIDED BY KEC
UNIT	TBD		EC TO INTERCONNECT AS REQUIRED
ORATOR	ABOVE		EC TO INTERCONNECT AS REQUIRED
	WALL	72"	EC TO INTERCONNECT AS REQUIRED
NDENSER	TBD		EC TO INTERCONNECT AS REQUIRED
	ABOVE		
	ABOVE		
	ABOVE		
HEAT	ABOVE		EC TO INTERCONNECT AS REQUIRED
	WALL	18"	
ILL STATION	WALL	48"	PROPOSED LOCATION FOR EXHAUST FIRE PROTECTION SYSTEM PROVIDED BY OTHERS
RS	WALL	18"	
२ऽ	WALL	18"	
	WALL	36"	
LS	WALL	18"	EC TO INTERCONNECT AS REQUIRED
	WALL	48"	BY OWNER - VERIFY REQUIREMENTS
	WALL	48"	BY OWNER - VERIFY REQUIREMENTS
	WALL	VERIFY	EC TO INTERCONNECT AS REQUIRED
LIGHTS	ABOVE		EC TO INTERCONNECT AS REQUIRED; 48" LED FIXTURE PROVIDED BY KEC
COND UNIT	TBD		EC TO INTERCONNECT AS REQUIRED
EVAP	ABOVE		EC TO INTERCONNECT AS REQUIRED
IINE	WALL	18"	BY OWNER - VERIFY REQUIREMENTS
	TBD		EC TO INTERCONNECT AS REQUIRED
	WALL	46"	MOUNT HORIZONTAL
	WALL	18"	<varies></varies>
	WALL	18"	
E DATA	WALL		EC TO FURNISH & INSTALL EMPTY CONDUIT FOR P.O.S . DATA TO CENTRAL LOCATION T.B.D
	WALL	18"	
R	WALL	18"	
OR	WALL	18"	

AFF	ABOVE FINISHED FLOOR
AMPS	AMPHERES
ARCH BTU	ARCHITECT BRITISH THERMAL UNITS
C&P	CORD & PLUG
CFM	CUBIC FEET PER MINUTE
C/L	CENTER LINE
CLG	CEILING
CLR	
CO COL	CONVENIENCE OUTLET COLUMN
CONC	CONCRETE
CONN	CONNECTION
CW	COLD WATER
DC	DIRECT CONNECTION
DBL	DOUBLE
DET DFA	DETAIL DOWN FROM ABOVE
DIA	DIAMETER
DIM	DIMENSION
DN	DOWN
DR	DOOR
DWG	DRAWING
EA EC	EACH ELECTRICAL CONTRACTOR
ELEV	ELEVATION
EQ	EQUAL
EQP	EQUIPMENT
EX	EXISTING
EXH	EXHAUST
FAB FD	FABRICATION
FIN	FLOOR DRAIN FINISH
FF	FINISH FLOOR
FLEX	FLEXIBLE
FLR	FLOOR
FPM	FEET PER MINUTE
FRP	FIBER REINFORCED PANEL
FS FUT	FLOOR SINK FUTURE
GA	GAUGE
GALV	GALVANIZED
GC	GENERAL CONTRACTOR
GPH	GALLONS PER HOUR
GPM	GALLONS PER MINUTE
GYP BD HORIZ	GYPSUM BOARD HORIZONTAL
HP	HORSEPOWER
нт	HEIGHT
HW	HOT WATER
ID	INSIDE DIMENSION
INSUL	INSULATION
IW	
JB KEC	JUNCTION BOX KITCHEN EQUIPMENT CONTRACTOR
KUC	KILOWATT
MAT	MATERIAL
MAX	MAXIMUM
MBTU	ONE THOUSAND BTU'S
MECH	MECHANICAL
MFG MILL	MANUFACTURER MILLWORK CONTRACTOR
MIN	MINIMUM
MUA	MAKE UP AIR
MTD	MOUNTED
NIC	
NO NSF	NUMBER NATIONAL SANITATION FOUNDATION
NTS	NOT TO SCALE
OC	ON CENTER
OD	OUTSIDE DIMENSION
OWN	
PC PH	PLUMBING CONTRACTOR PHASE
PSI	POUNDS PER SQUARE INCH
QTY	QUANTITY
R	RADIUS
RD	ROOF DRAIN
REQ	REQUIRED
REV RM	REVISION
SF	ROOM SQUARE FEET
SIM	SIMILIAR
SHT	SHEET
SP	STATIC PRESSURE
SPECS	SPECIFICATIONS SQUARE
SQ SQ FT	SQUARE SQUARE FEET
S/S	STAINLESS STEEL
STD	STANDARD
SW	SWITCH
TEMP	TEMPERATURE
TYP V	TYICAL VOLTS
V VEND	VENDOR
W	WATTS
WGT	WEIGHT

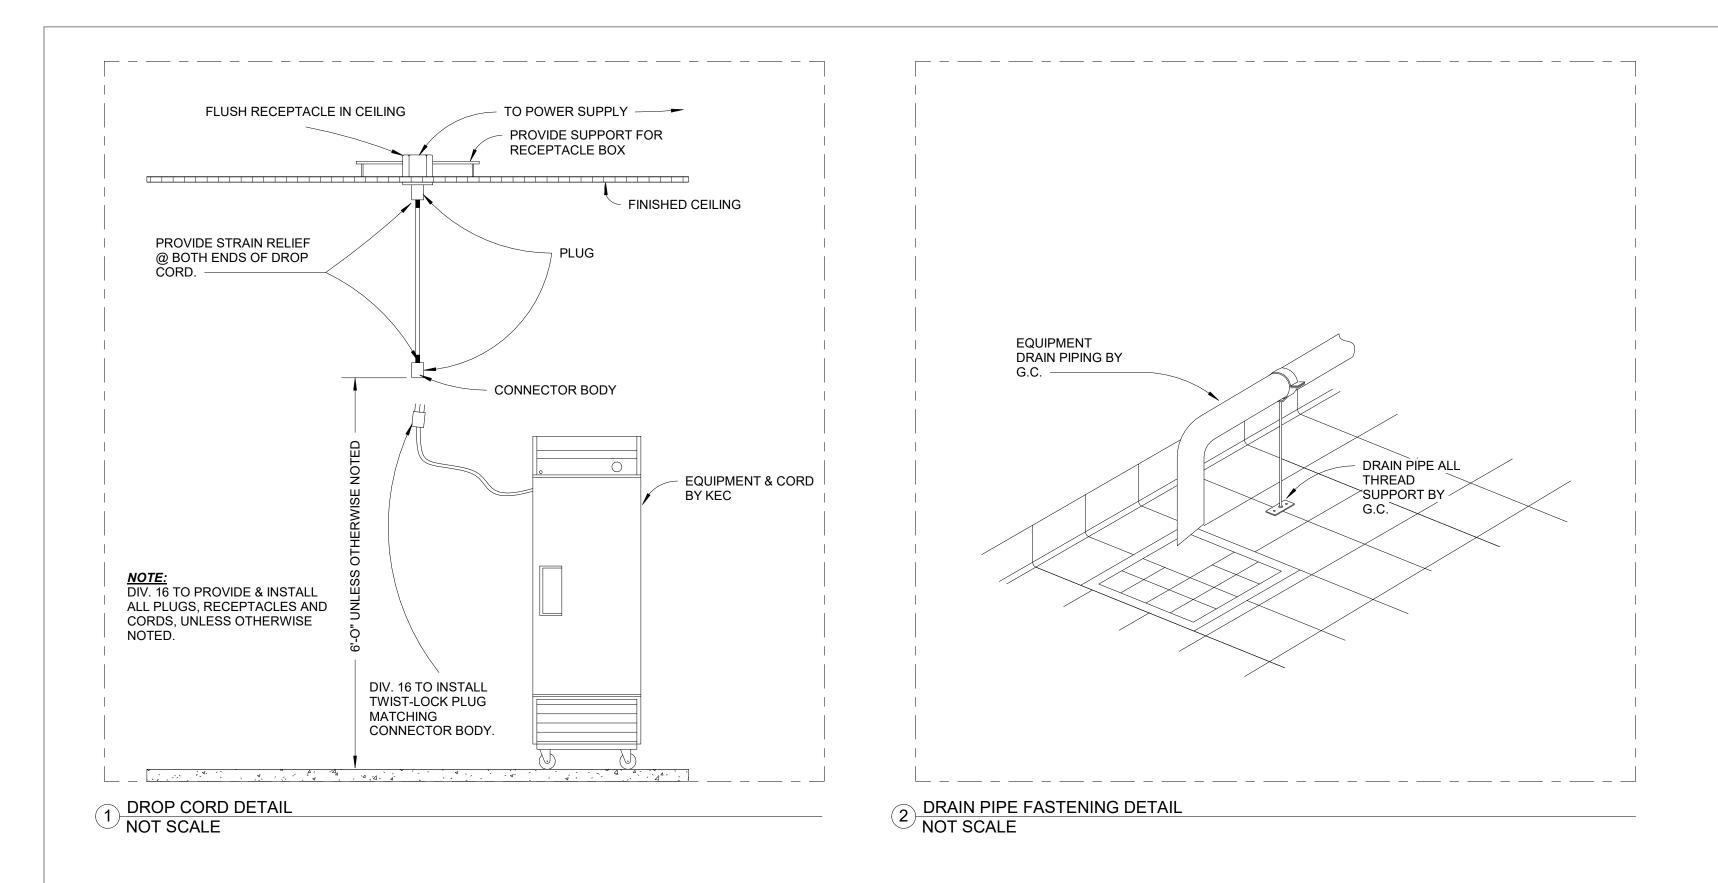
	FOODSERVICE ELECTRICAL SCHEDULE								
NO									
E1	JB	3.0A	120	1	WALK IN FREEZER LIGHTS	ABOVE		EC TO INTERCONNECT AS REQUIRED; 48" LED FIXTURE PROVIDED BY KEC	
E1.1	JB/DS	20.0A	208-230	1	WALK IN FREEZER COND UNIT	TBD		EC TO INTERCONNECT AS REQUIRED	
E1.2	JB	12.0A	208-230	1	WALK IN FREEZER EVAPORATOR	ABOVE		EC TO INTERCONNECT AS REQUIRED	
E1.3	WPR	20.0A	120	1	WALK IN FREEZER HEAT TAPE	WALL	48"	EC TO FURNISH & INSTALL WEATHERPROOF RECEPTACLE TO SERVICE THE FREEZER HEAT TAPE.	
E3	JB	3.0A	120	1	WALK IN COOLER LIGHTS	ABOVE		EC TO INTERCONNECT AS REQUIRED; 48" LED FIXTURE PROVIDED BY KEC	
E3.1	JB/DS	15.0A	208-230	1	WALK IN COOLER COND UNIT	TBD		EC TO INTERCONNECT AS REQUIRED	
E3.2	JB	2.0A	115	1	WALK IN COOLER EVAPORATOR	ABOVE		EC TO INTERCONNECT AS REQUIRED	
E4	JB	1.1A	115	1	ICE MAKER	WALL	72"	EC TO INTERCONNECT AS REQUIRED	
E4.1	JB/DS	20.0A	208-230	1	ICE MAKER REMOTE CONDENSER	TBD		EC TO INTERCONNECT AS REQUIRED	
E14	DC	8.6A	115	1	REACH IN FREEZER	ABOVE			
E15	DC	3.2A	115	1	REACH IN COOLER	ABOVE			
E18	DC	13.4A	120	1	MICROWAVES	ABOVE			
E19	JB	6.7A	120	1	FOOD WARMER - STRIP HEAT	ABOVE		EC TO INTERCONNECT AS REQUIRED	
E20	DR	2.8A	115	1	SANDWICH/ SALAD UNIT	WALL	18"		
E21	FP				EXHAUST HOOD FIRE PULL STATION	WALL	48"	PROPOSED LOCATION FOR EXHAUST FIRE PROTECTION SYSTEM PROVIDED BY OTHERS	
E22	DR	2.3A	115	1	REFRIGERATED DRAWERS	WALL	18"		
E24	DR	2.3A	115	1	REFRIGERATED DRAWERS	WALL	18"		
E29	DR	7.9A	120	1	CONVECTION OVEN	WALL	36"		
E31	JB	16.0A	120	1	DROP IN HOT FOOD WELLS	WALL	18"	EC TO INTERCONNECT AS REQUIRED	
E33	JB	20.0A	208-230	1	COFFEE BREWER	WALL	48"	BY OWNER - VERIFY REQUIREMENTS	
E34	JB	20.0A	208-230	1	TEA BREWER	WALL	48"	BY OWNER - VERIFY REQUIREMENTS	
E43	JB/DS	46.0A	208-240	3	DISHWASHER	WALL	VERIFY	EC TO INTERCONNECT AS REQUIRED	
E48	JB	3.0A	120	1	WALK IN BEER COOLER LIGHTS	ABOVE		EC TO INTERCONNECT AS REQUIRED; 48" LED FIXTURE PROVIDED BY KEC	
E48.1	JB/DS	15.0A	208-230	1	WALK IN BEER COOLER COND UNIT	TBD		EC TO INTERCONNECT AS REQUIRED	
E48.2	JB	11.0A	208-230	1	WALK IN BEER COOLER EVAP	ABOVE		EC TO INTERCONNECT AS REQUIRED	
E52	JB	VERIFY	VERIFY			WALL	18"	BY OWNER - VERIFY REQUIREMENTS	
E53	JB/DS	VERIFY	VERIFY		REMOTE BEER SYSTEM	TBD		EC TO INTERCONNECT AS REQUIRED	
E100	DR	20.0A	120	1	CONVENIENCE OUTLET	WALL	46"	MOUNT HORIZONTAL	
E101	DR	20.0A	120	1	CONVENIENCE OUTLET	WALL	18"	<varies></varies>	
EB10	DR	10.0A	120	1	OWNERS POINT OF SALE	WALL	18"		
EB11	CS				OWNERS POINT OF SALE DATA	WALL		EC TO FURNISH & INSTALL EMPTY CONDUIT FOR P.O.S . DATA TO CENTRAL LOCATION T.B.D	
EB12	DR	3.8A	120	1	GLASS FROSTER	WALL	18"		
EB17	JB	33.0A	208	1	UNDERBAR DISHWASHER	WALL	18"		
EB19	DR	4.2A	120	1	BACK BAR REFRIGERATOR	WALL	18"		

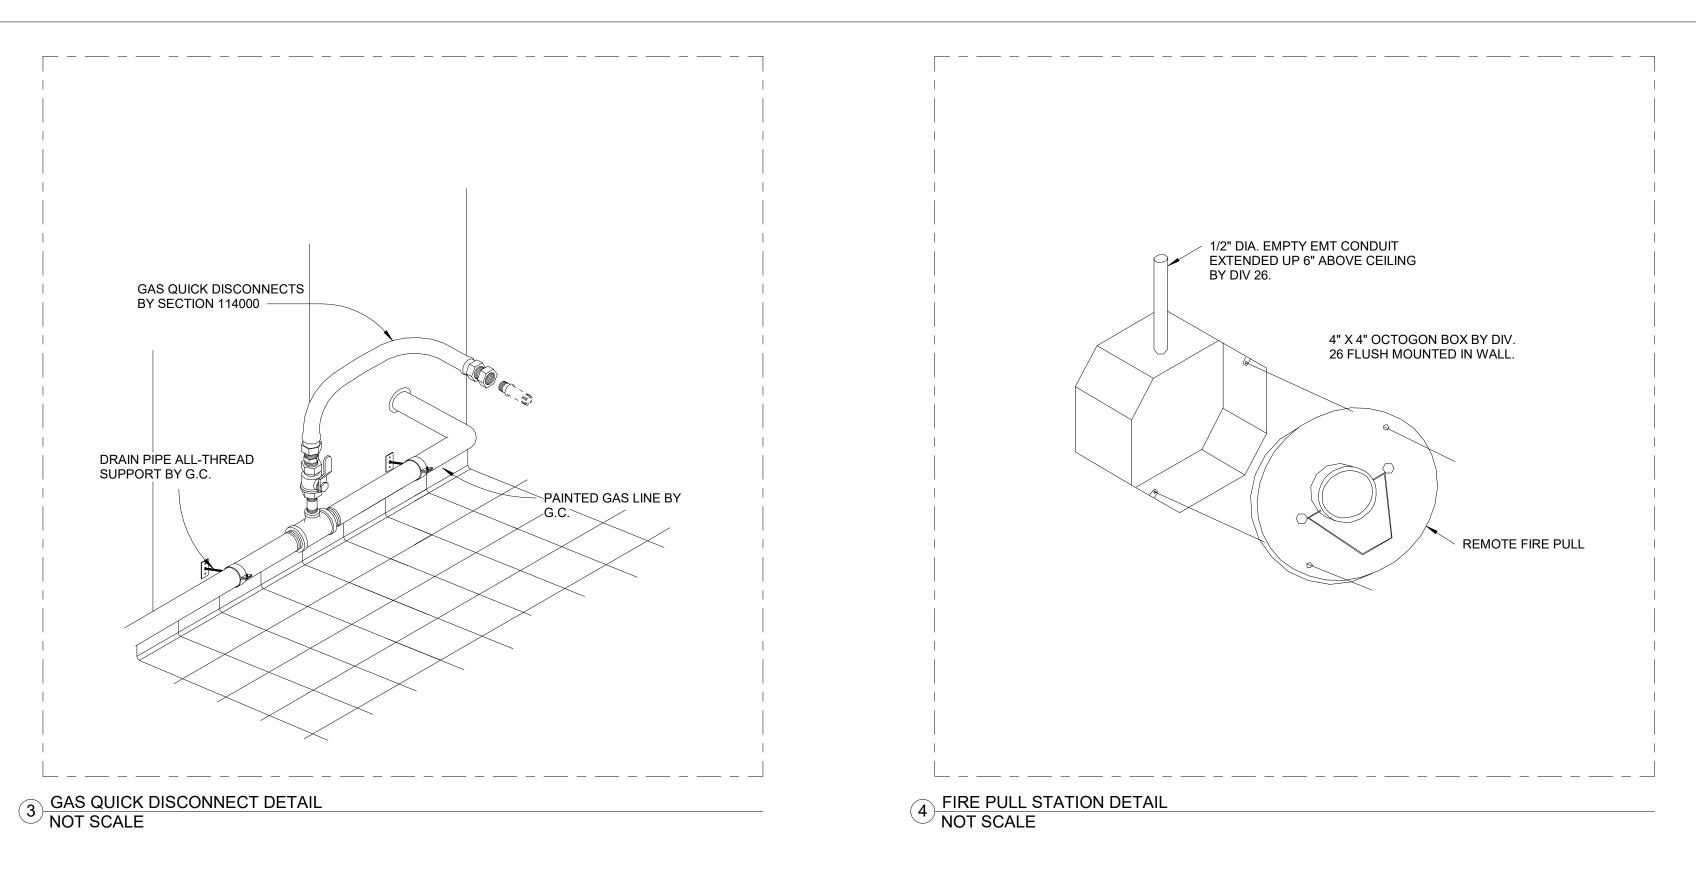
NO	SIZE	CONNECTION	SERVICE TO	LOCATON	AFF	REMARKS
P1		FD	WALK INS	FLOOR		
P3	1"	IW	WALK IN EVAPORATORS			PC TO ROUTE CONDENSATE DRAINS FROM WALK IN EVAPORATORS TO FD; PROVIDE MIN 1" AIR GAP
P4	1/2"	CW	ICE MACHINE	WALL	78"	PC TO ROUTE CW THRU WATER FILTER PROVIDED BY KEC
P4.1	1"	IW	ICE MACHINE			ROUTE TO FLOOR TROUGH; DO NOT INTERCONNECT WITH ANY OTHER DRAIN; PROVIDE MIN 1" AIR GAP @ TERMINATION
P5	1"	IW	ICE MACHINE BIN			ROUTE TO FLOOR TROUGH; DO NOT INTERCONNECT WITH ANY OTHER DRAIN; PROVIDE MIN 1" AIR GAP @ TERMINATION
P5.1	VERIFY	FT	ICE MACHINE	FLOOR		FLOOR TROUGH PROVIDED BY PC
P23	3/4"	NG	SIX OPEN BURNERS	WALL	24"	PC TO ROUTE THRU GAS QUICK CONNECT PROVIDED BY KEC; 192 MBTU
P25	3/4"	NG	GRIDDLE	WALL	24"	PC TO ROUTE THRU GAS QUICK CONNECT PROVIDED BY KEC; 90 MBTU
P26	3/4"	NG	CHEESEMELTER	WALL	24"	PC TO ROUTE THRU GAS QUICK CONNECT PROVIDED BY KEC; 43 MBTU
P27	3/4"	NG	CHARBROILER	WALL	24"	PC TO ROUTE THRU GAS QUICK CONNECT PROVIDED BY KEC; 70 MBTU
P28	3/4" (2EA)	NG	FRYER	WALL	24"	PC TO ROUTE THRU GAS QUICK CONNECT PROVIDED BY KEC; 102 (EA) MBTU
P29	3/4"	NG	CONVECTION OVEN	WALL	24"	PC TO ROUTE THRU GAS QUICK CONNECT PROVIDED BY KEC; 72 MBTU
P33	3/8"	CW	COFFEE BREWER	WALL	48"	COFFEE BREWER BY OWNER - VERIFY REQUIREMENTS
P34	3/8"	CW	TEA BREWER	WALL	48"	TEA BREWER BY OWNER - VERIFY REQUIRMENTS
P35	3/8"	CW	WATER FILL STATION	WALL	18"	
P43	3/4"HW ; 1/2" CW	HW & CW	DISHMACHINE	WALL	18"	110° MIN INCOMING HW
P43.1	1"	IW	DISHMACHINE			PC TO ROUTE IW TO NEAREST FS; PROVIDE MIN 1" AIR GAP @ TERMINATION
P52	1/2"	CW	FREESTYLE COKE MACHINE	WALL	24"	BY OWNER - VERIFY REQUIREMENTS
P55	VERIFY	DW	MOP SINK	FLOOR		
P55.1	3/4"	HW & CW	MOP SINK SVC FAUCET	WALL	36"	
P58	1/2"	CW	BAG 'N BOX	WALL	36"	
P100	12" SQ	FS	FOODSERVICE EQUIPMENT	FLOOR		
P101		FD	GENERAL AREA DRAIN	FLOOR		GENERAL AREA DRAIN; SHOWN FOR REFERENCE ONLY; REFER TO ENGINEERED PLUMBING DRAWINGS FOR EXACT LOCATION & QUANTITY
P102	1/2"	HW & CW	FOODSERVICE FAUCET 8" CENTERS	WALL	18"	
P103	1/2"	HW & CW	FOODSERVICE FAUCET 4" CENTERS	WALL	18"	
P104	1 1/2" - 2 1/2"	IW	FOODSERVICE EQUIPMENT			PC TO ROUTE IW TO NEAREST FS; PROVIDE MIN 1" AIR GAP @ TERMINATION
P105	1 1/2"	DW	HAND SINK	WALL	20"	
PB17	1"	HW	UNDERBAR DISH MACHINE	WALL	18"	

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	KIOWA CASINO	HOBART, OKLAHOMA	
	FOODSERV SCHEDULES	/ICE EQUIPI S / ABBREVI	
Date:			1/4" = 1'-0"
Drawn OSW Check N/A	I	<b>K-(</b>	)50

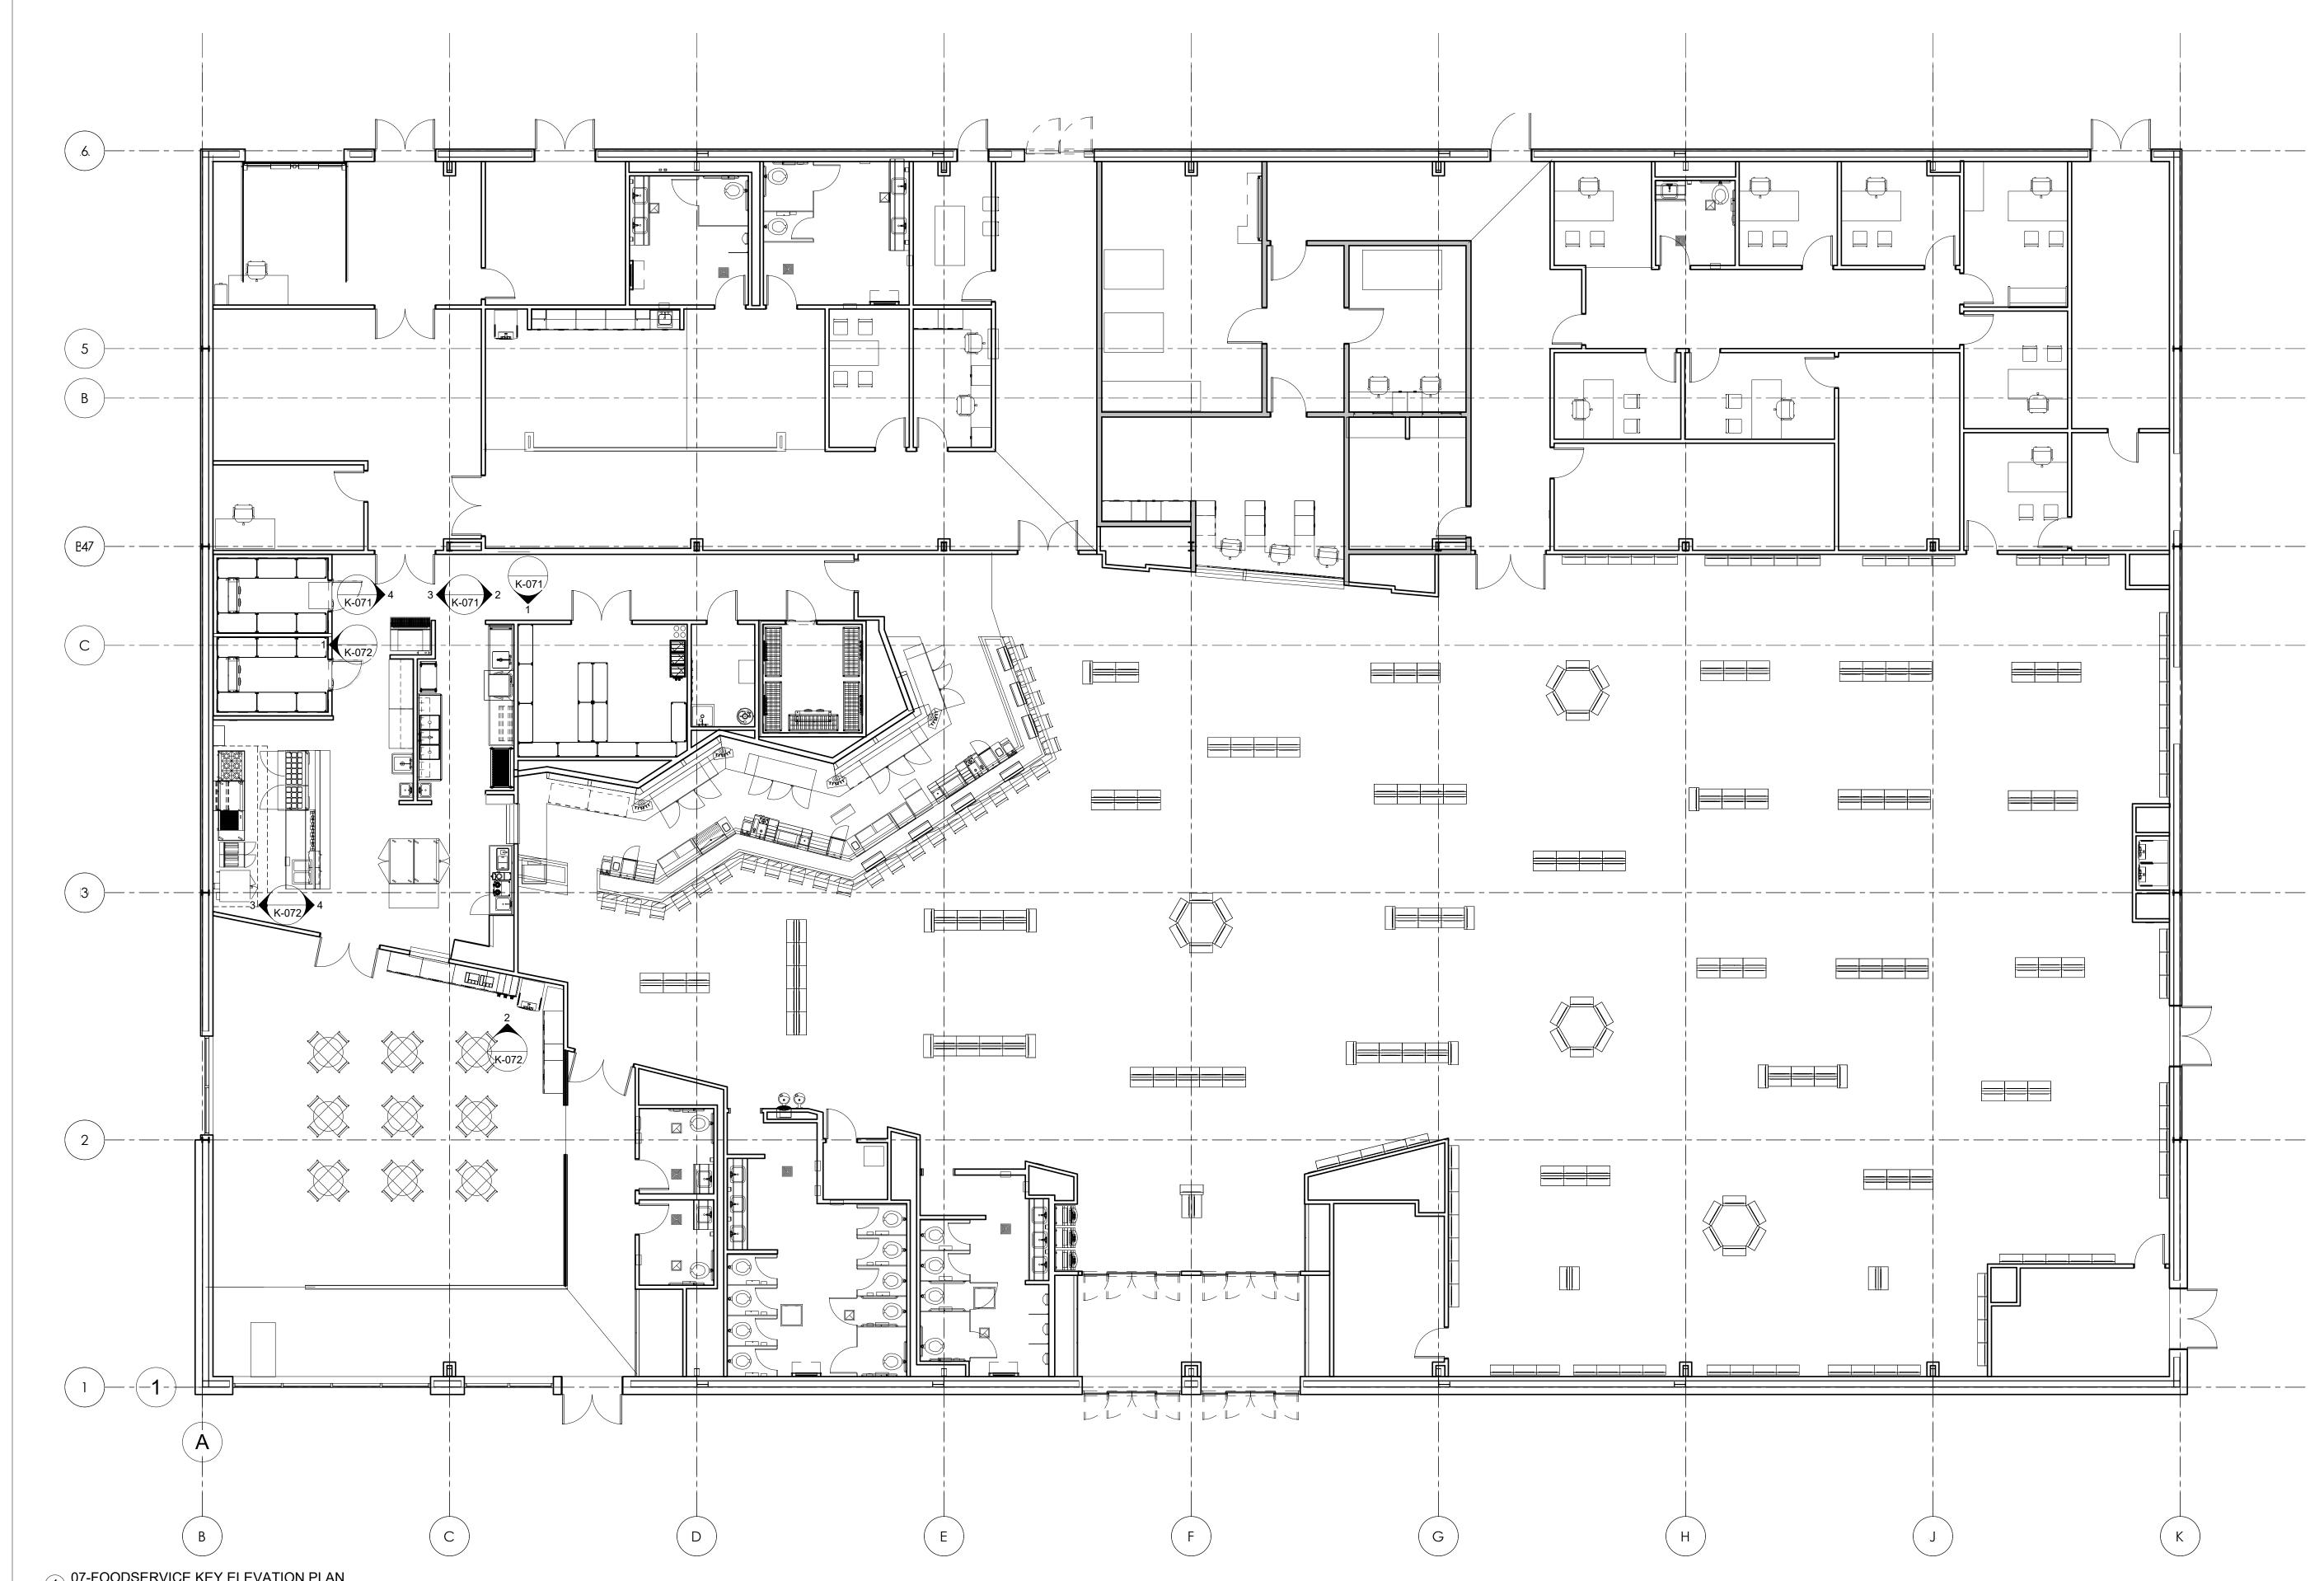
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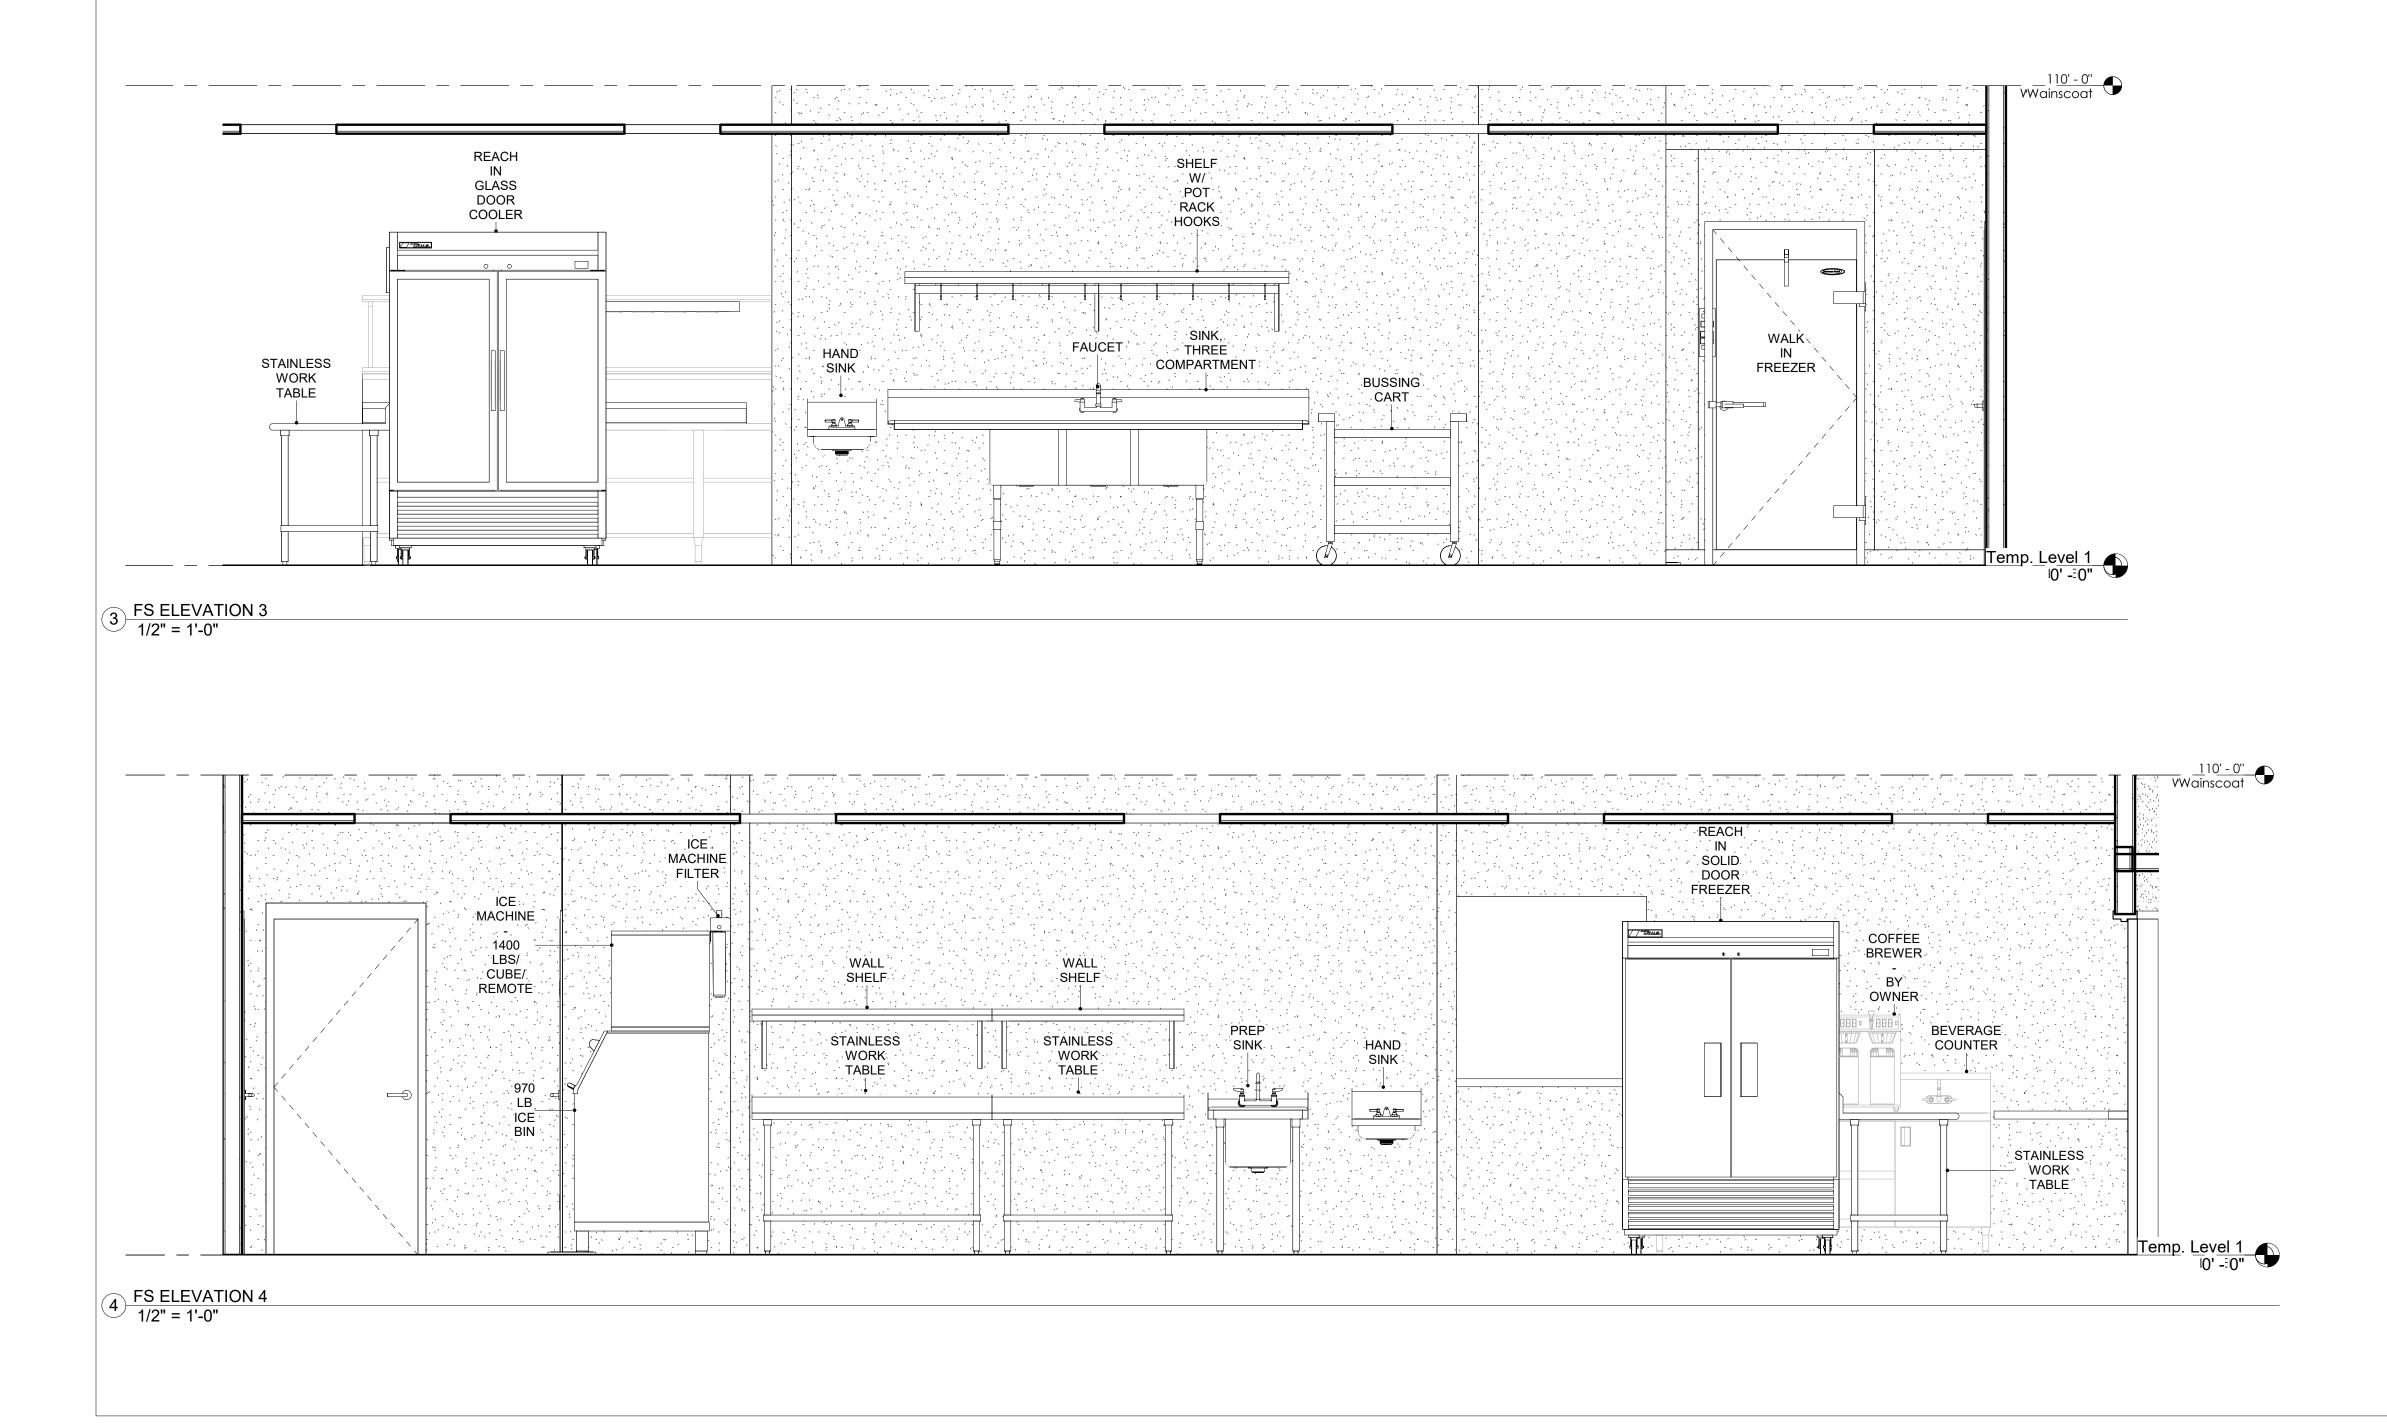
<b>C</b>	)SV		
	Oklahoma	nterprise I City, OK 405-843	73128
Rev		scription	Date
Projec	t Title:		
	KIOWA CASINO	HOBART, OKLAHOMA	
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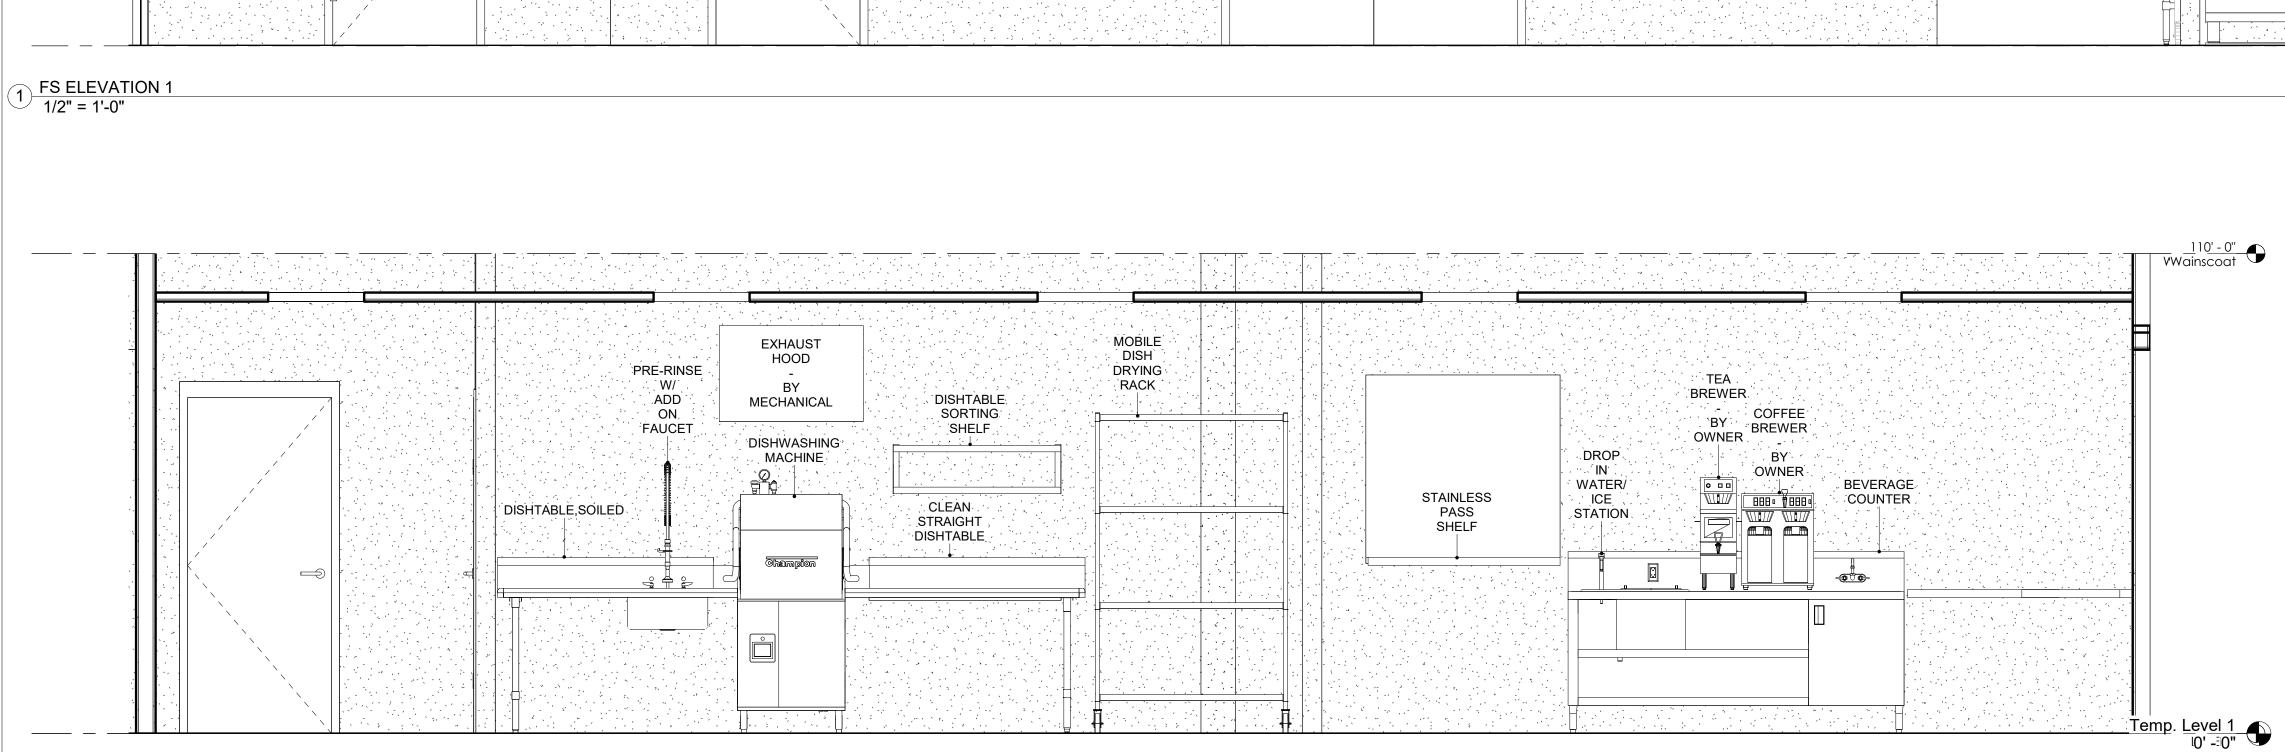


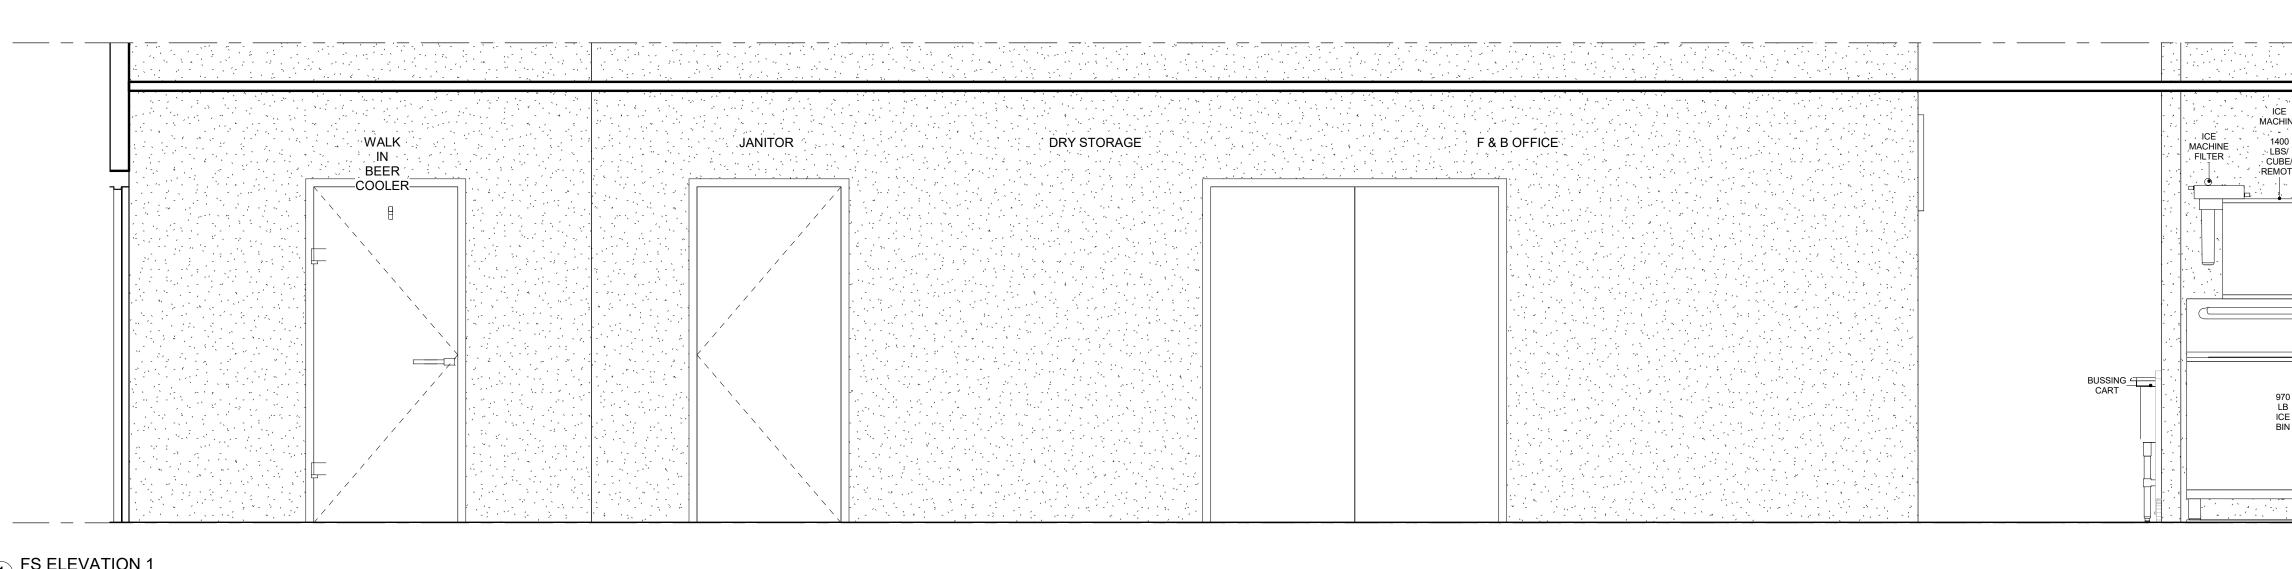
1 07-FOODSERVICE KEY ELEVATION PLAN 1/8" = 1'-0"

<b>C</b>	)51	NA	
	Oklahoma	nterprise Dri i City, OK 73 405-843-90	3128
Rev	Des	scription	Date
Projec	t Title:		
	KIOWA CASINO	HOBART, OKLAHOMA	
Sheet F(		CE KEY ELE Plan	VATION
	17, 2024		1/8" = 1'-0"
Drawn OSW Check N/A	I	<b>K-(</b>	)70



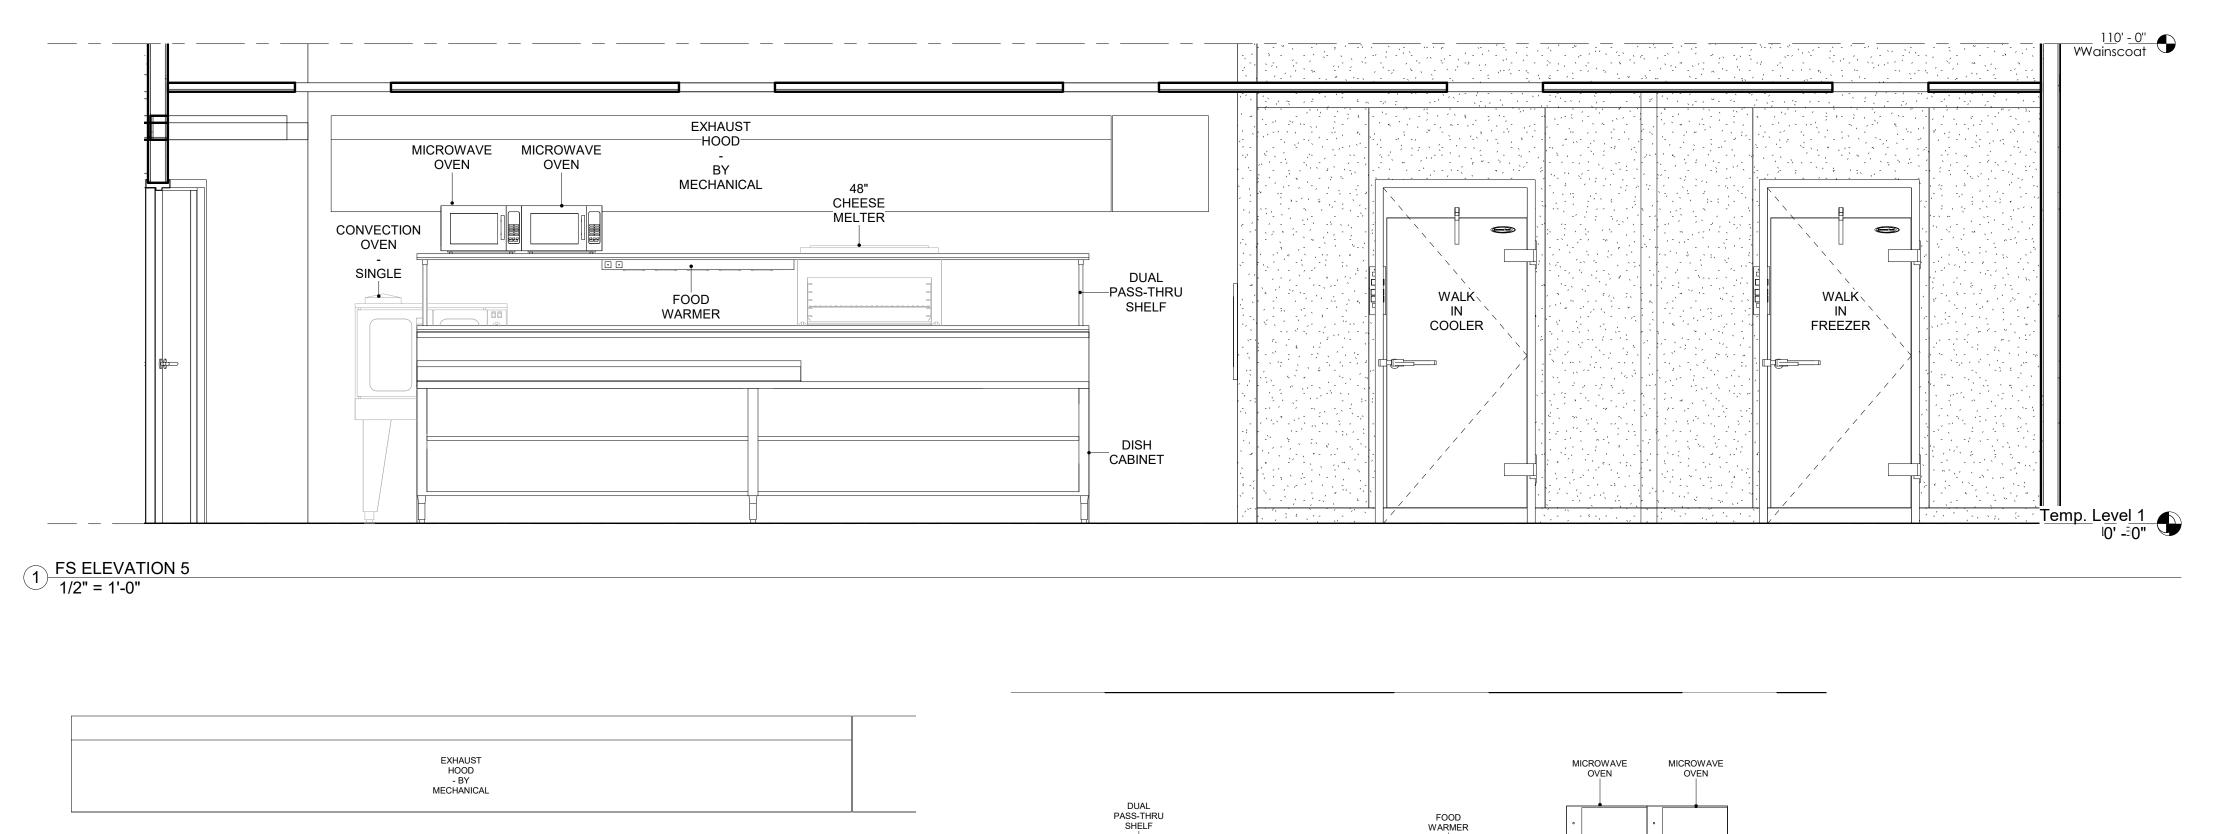
#### 2 FS ELEVATION 2 1/2" = 1'-0"

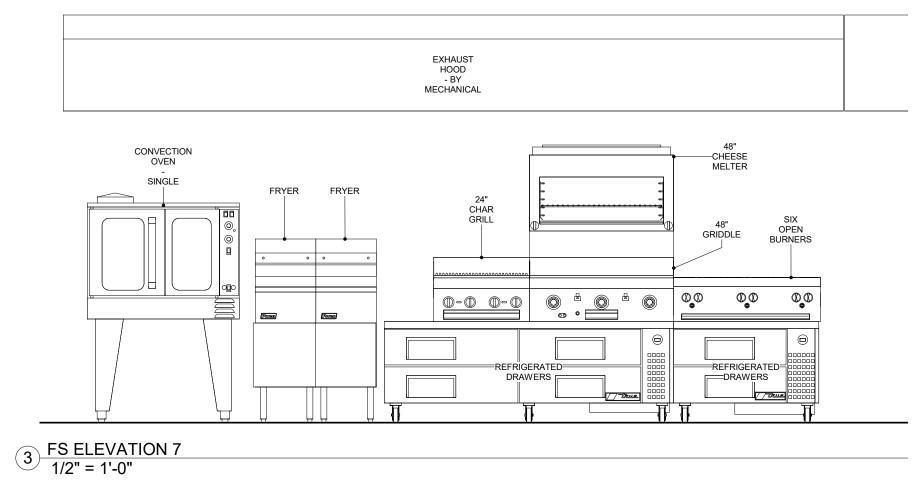


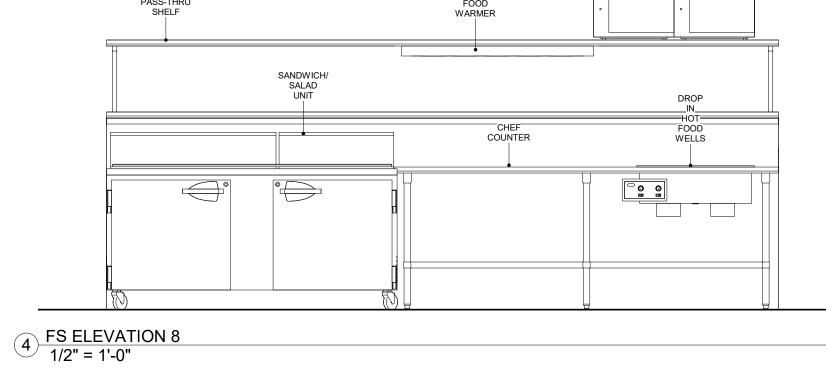


110' 0' VWainscoat		
כ	WALK IN FREEZER	E HINE: S/ S/ DTE: TE: TE: TE: TE: TE: TE: TE: TE: TE:
7		70 B E N
<u>emp. Level 1</u> 0' - <sup>:</sup> 0'		

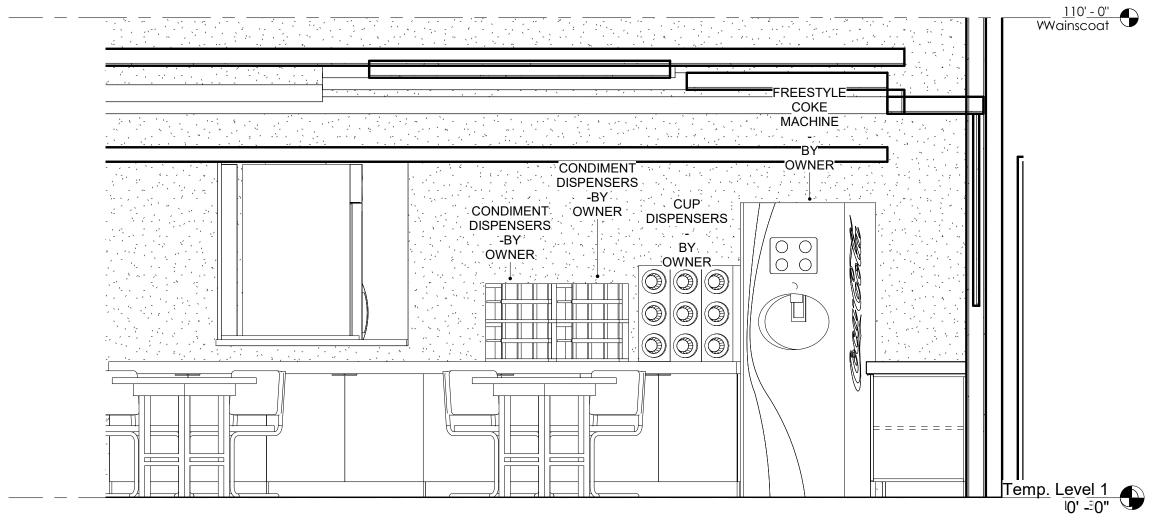
	)SV	NA	
	Oklahoma	nterprise Dri City, OK 73 405-843-9	3128
Rev	Des	cription	Date
Projec	t Title:		
Project	KT Title:	HOBART, OKLAHOMA	
Sheet	KIOWA CASINO		
Sheet Date:	KIOWA CASINO	ICE ELEVA	
Sheet Date:	Title: FOODSERV 17, 2024	ICE ELEVA	1/2" = 1'-0"





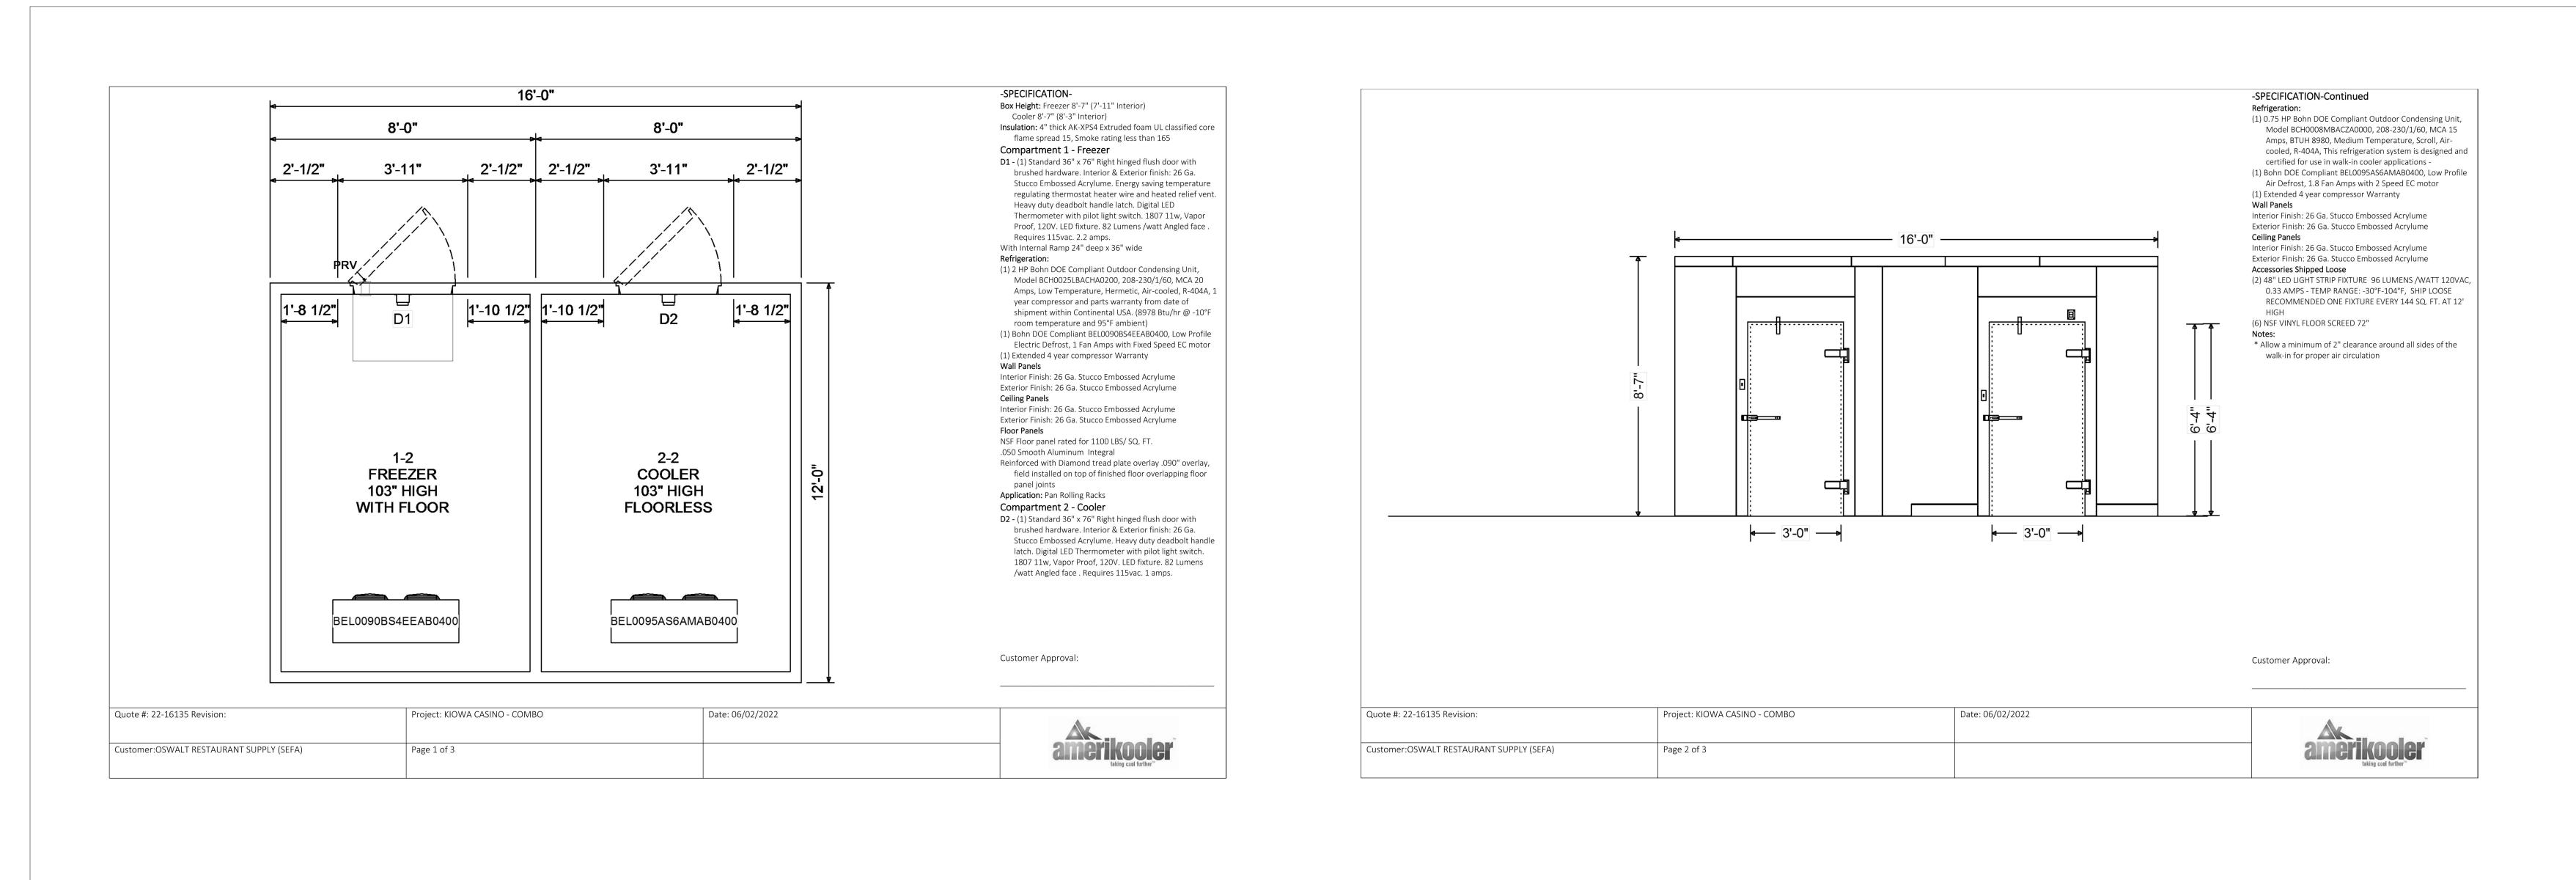


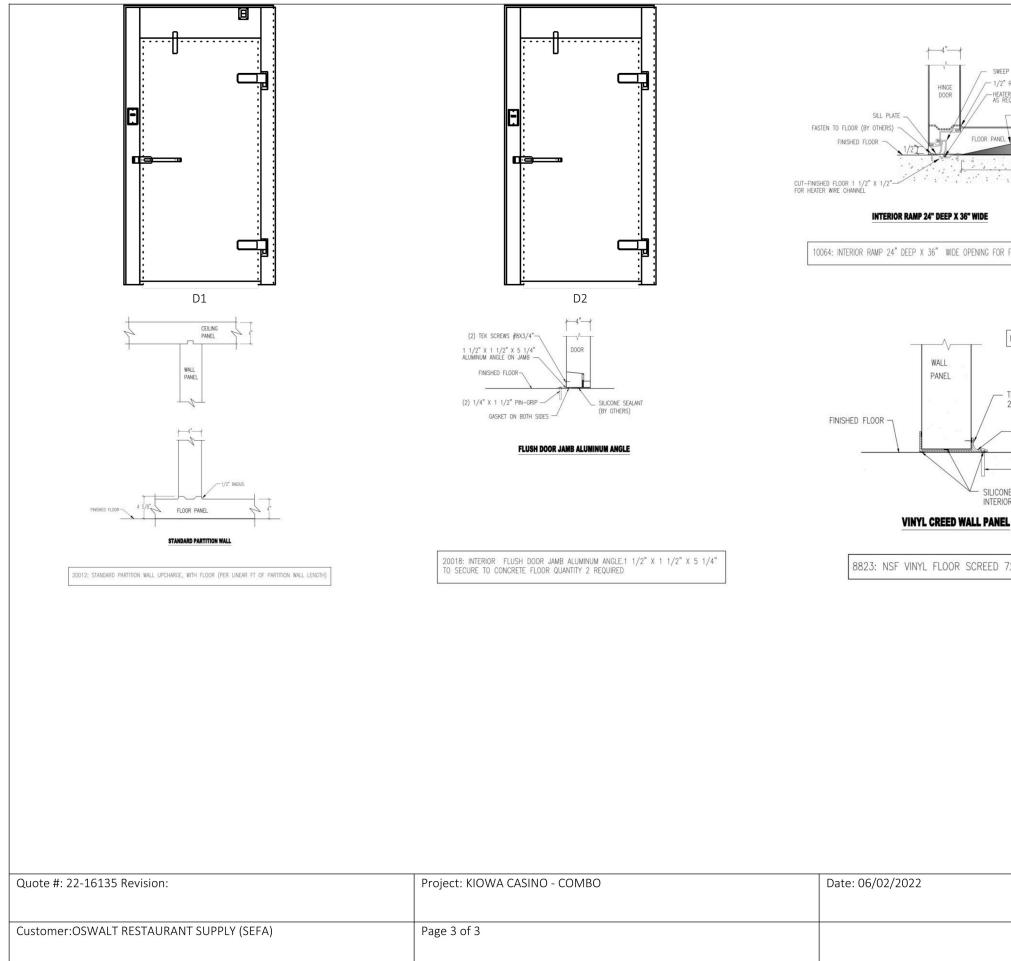
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2 FS ELEVATION 6 1/2" = 1'-0"

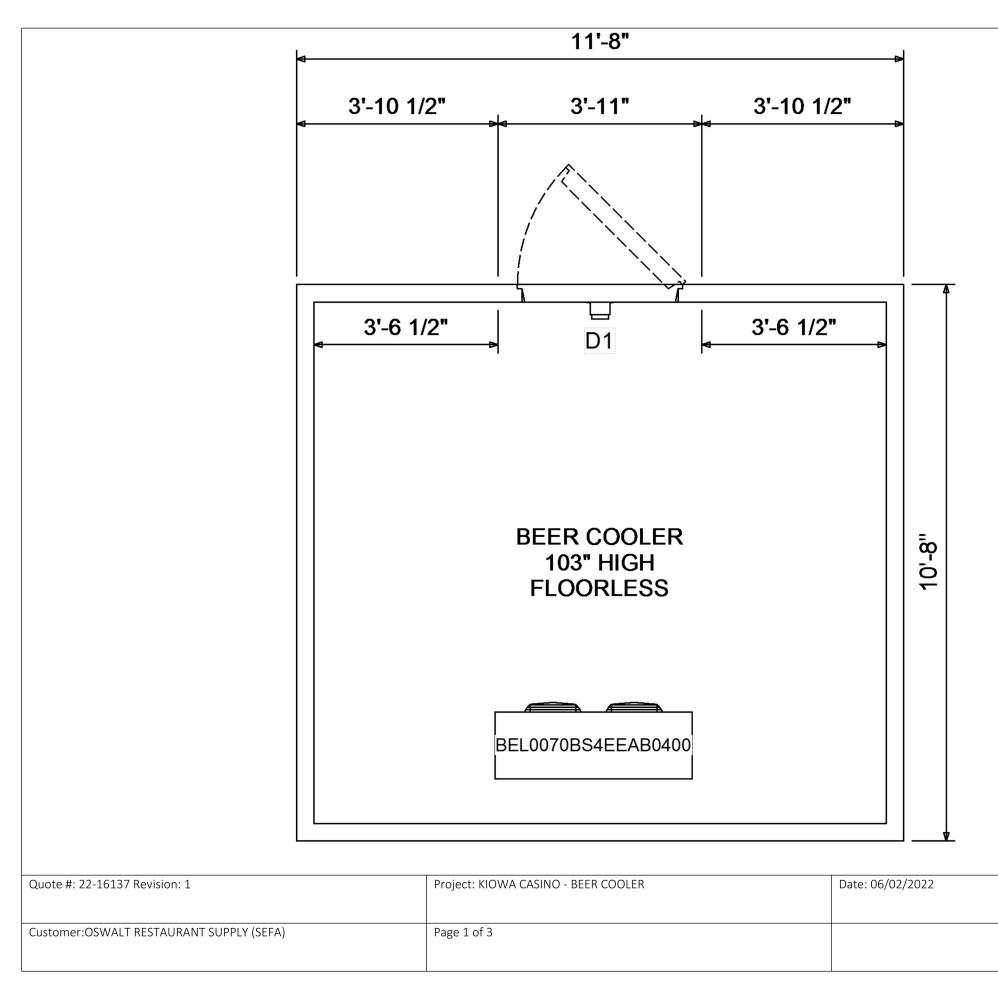
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	KIOWA CASINO	HOBART, OKLAHOMA	
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Date:	FOODSERV 17, 2024	Scale:	ATIONS 1/2" = 1'-0"
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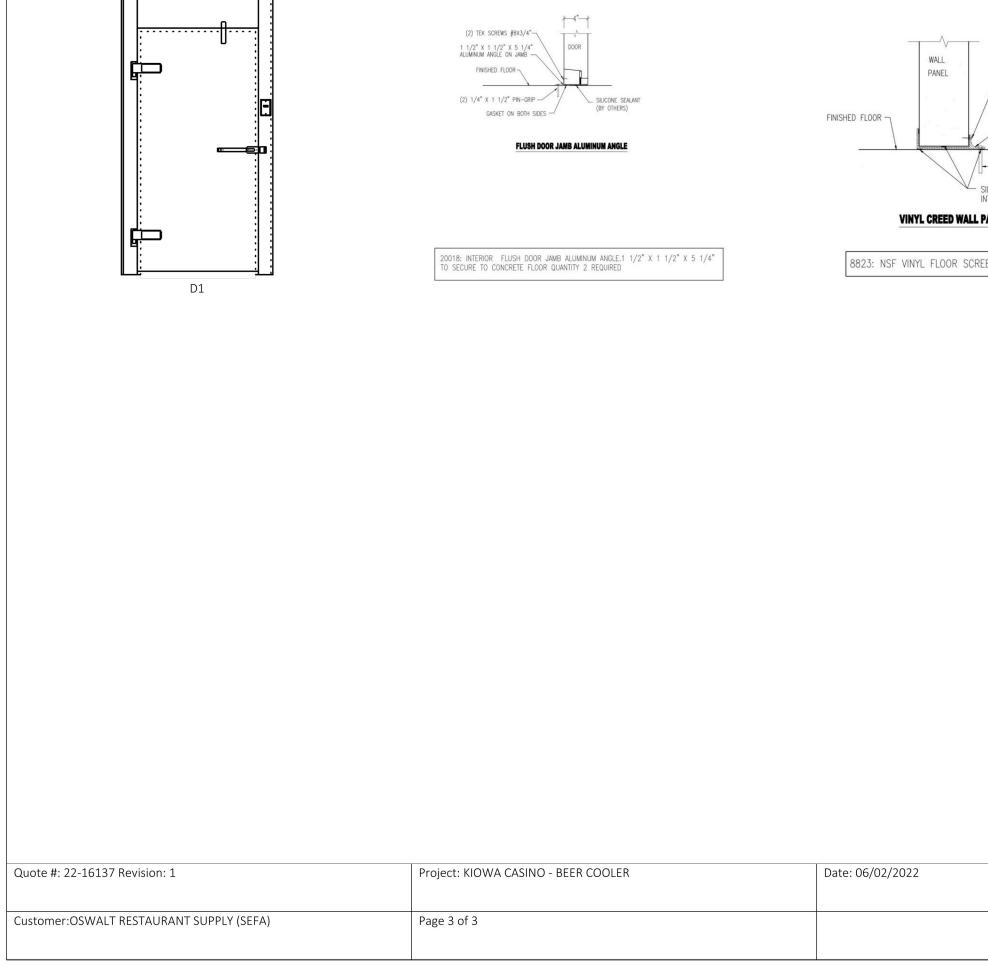




REEP GASKET (2" RADIUS ATER WIRE FOR FREEZERS REQUERO INTERIOR RAMP WITH THREADPLATE 4 5/8" 24" 0R FREEZER (5.7 OHMS HEATER WIRE)	FLOOR 4 WALL DETAIL (1100 LBS / FT, DIST. LOAD) TC: NSF FLOOR .050 SMOOTH ALUMINUM INTEGRAL. REINFORCED WITH .090 ALUMINUM DIAMOND TREAD PLATE OVERLAY 'PRE-CUT', FIELD INSTALLED ON TOP OF FINISH FLOOR OVERLAPPINE FLOOR PANEL JOINTS RATED FOR 1100 LBS / SQ FT (APPLICATION: ROLLING PAN RACKS)
INTERIOR OF WALK-IN  - TEK SCREWS #8X3/4" 20" ON CENTERS	

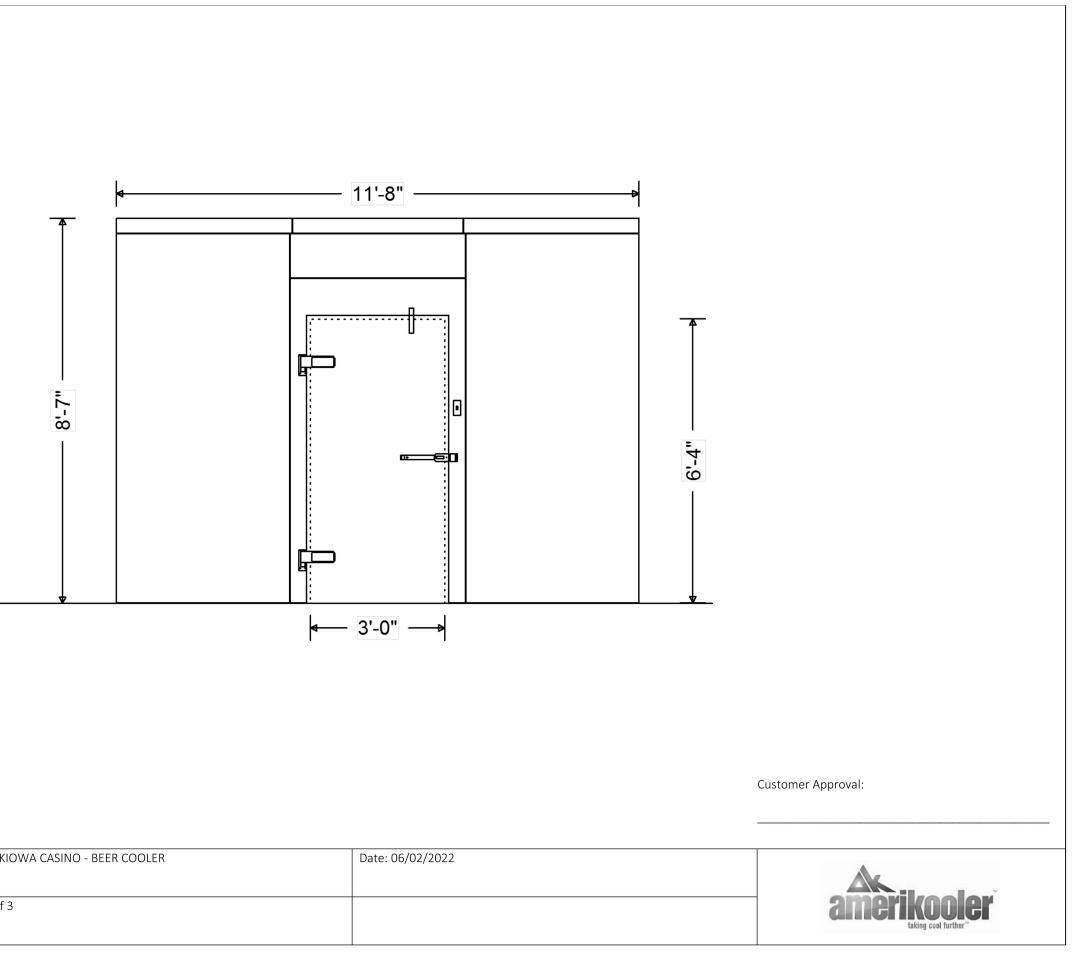
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		Customer:OSWALT RESTAURANT SUPPLY (SEFA)	Page 2 of 3
		Quote #: 22-16137 Revision: 1	Project: Kl
Customer Approval:			
* Allow a minimum of 2" clearance around all sides of the walk-in for proper air circulation			
HIGH (7) NSF VINYL FLOOR SCREED 72" <b>Notes:</b>			
<ul> <li>(1) 48" LED LIGHT STRIP FIXTURE 96 LUMENS /WATT 120VAC,</li> <li>0.33 AMPS - TEMP RANGE: -30°F-104°F, SHIP LOOSE</li> <li>RECOMMENDED ONE FIXTURE EVERY 144 SQ. FT. AT 12'</li> </ul>			
Interior Finish: 26 Ga. Stucco Embossed Acrylume Exterior Finish: 26 Ga. Stucco Embossed Acrylume			
Interior Finish: 26 Ga. Stucco Embossed Acrylume Exterior Finish: 26 Ga. Stucco Embossed Acrylume <b>Ceiling Panels</b>			
(1) Defrost Timer (1) Extended 4 year compressor Warranty <b>Wall Panels</b>			
(1) Bohn DOE Compliant BEL0070BS4EEAB0400, Low Profile Electric Defrost, 1 Fan Amps with Fixed Speed EC motor			
Amps, BTUH 12200, Medium Temperature, Scroll, Air- cooled, R-404A, This refrigeration system is designed and			
(1) 1 HP Bohn DOE Compliant Outdoor Condensing Unit,			
1807 11w, Vapor Proof, 120V. LED fixture. 82 Lumens /watt Angled face . Requires 115vac. 1 amps.			
Stucco Embossed Acrylume. Heavy duty deadbolt handle latch. Digital LED Thermometer with pilot light switch.			
D1 - (1) Standard 36" x 76" Left hinged flush door with			
flame spread 15, Smoke rating less than 165			
Insulation: 4" thick AK-XPS4 Extruded foam UL classified core			
_	Compartment 1 - Beer Cooler D1 - (1) Standard 36" x 76" Left hinged flush door with brushed hardware. Interior & Exterior finish: 26 Ga. Stucco Embossed Acrylume. Heavy duty deadbolt handle latch. Digital LED Thermometer with pilot light switch. 1807 11w, Vapor Proof, 120V. LED fixture. 82 Lumens /watt Angled face . Requires 115vac. 1 amps. <b>Refrigeration:</b> (1) 1 HP Bohn DOE Compliant Outdoor Condensing Unit, Model BCH0010MBACZA0000, 208-230/1/60, MCA 15 Amps, BTUH 12200, Medium Temperature, Scroll, Air- cooled, R-404A, This refrigeration system is designed and certified for use in walk-in cooler applications - (1) Bohn DOE Compliant BLL0070BS4EEAB0400, Low Profile Electric Defrost, 1 Fan Amps with Fixed Speed EC motor (1) Defrost Timer (1) Extended 4 year compressor Warranty Wall Panels Interior Finish: 26 Ga. Stucco Embossed Acrylume Exterior Finish: 26 Ga. Stucco Embossed Acrylume (1) 48" LED LIGHT STRIP FIXTURE 96 LUMENS /WATT 120VAC, 0.33 AMPS - TEMP RANGE: -30"F-104"F, SHIP LOOSE RECOMMENDED ONE FIXTURE EVERY 144 SQ. FT. AT 12' HIGH (7) NSF VINYL FLOOR SCREED 72" Notes: * Allow a minimum of 2" clearance around all sides of the	<ul> <li>Compartment 1 - Beer Cooler</li> <li>D1 - (1) Standard 36" x 76" Left hinged flush door with brushed hardware. Interior &amp; Exterior finish: 26 Ga. Stucco Embossed Acrylume. Heavy duty deadbolt handle latch. Digital LED Thermometer with pilot light switch. 1807 11.W, Vapor Proof. 120V. LED fixture. 82 Lumens /watt Angled face. Requires 115vac. 1 amps.</li> <li>Refrigeration: <ol> <li>11 HP Bohn DOE Compliant Outdoor Condensing Unit, Model BCH0010MBACZA0000, 208-230/1/60, MCA 15 Amps, BTU 12200, Medium Temperature, Scroll, Aircooled, R-404A, This refrigeration system is designed and certified for use in walk-in cooler applications -</li> <li>Bohn DOE Compliant BEL0070BS4EEAB0400, Low Profile Electric Defrost, 1 Fan Amps with Fixed Speed EC motor</li> <li>Defrost Timer</li> <li>Extended 4 year compressor Warranty</li> </ol> </li> <li>Vall Panels Interior Finish: 26 Ga. Stucco Embossed Acrylume Celling Panels Interior Finish: 26 Ga. Stucco Embossed Acrylume Exterior Finish: 26 Ga. Stucco Embossed Acrylume Caressories Shipped Loose (1) 48" LED LIGHT STRIP FIXTURE 96 LUMENS /WATT 120VAC, 0.33 AMPS - TEMP RANGE: 30°F-104°F, SHIP LOOSE RECOMMENDED ONE FIXTURE EVERY 144 SQ. FT. AT 12° HIGH (7) NSF VINLE FLOOR SCREED 72" Note: <ul> <li>* Allow a minimum of 2" clearance around all sides of the walk-in for proper air circulation</li> </ul></li></ul>	Compartment 1 - Beer Cooler D. 1; Stranders 37: X7 lict hinge Huch door with brucket bardware, meirar & Keterior finishe 26 Ga. Succes Smootsek Arylume, Heavy doy dealbolt handle latch. Diglal LCD Thermoneter with pilot light switch. 1800/11:W, Yaper Kolz, X0: LD Mohare & Burness Avet Angles free Compliant Durkare Condening Lint; Medis BreijOLDMAR (20200), LCB 20:30/14:C. compliant Durkare LDSMAR (2020), LCB 20:30/14:C. Customer Approval: Customer Approval:

INTERIOR OF WALK-IN	
TEK SCREWS #8X3/4" 20" ON CENTERS VINYL SCREED NSF	
PIN-GRIP @ 20" O.C. SILICONE SEALANT (BY OTHERS) INTERIOR AND EXTERIOR	
IL PANEL Creed 72"	
	amerikooler taking cool further



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	Oklahoma	nterprise I City, OK 405-843	73128
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